

特記仕様書

工事名称 本郷ひまわり保育所エアコン更新工事

工事場所 三原市下北方一丁目

工事内容 本郷ひまわり保育所のエアコンの更新工事を行う。

【工事概要】

空調設備改修工事

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|---------|-----|---------|---------|
| マルチエアコン | 屋外機 | 560型 | 3台 |
| | 屋内機 | 天吊型 | 140型 8台 |
| | | 天井カセット型 | 80型 2台 |
| | | 天井カセット型 | 56型 1台 |

準 則 公共建築工事標準仕様書(建築工事編・電気設備工事編・機械設備工事編)、公共建築改修工事標準仕様書(建築工事編・電気設備工事編・機械設備工事編)、建築物解体工事共通仕様書（各 令和7年版 国土交通省官房官庁営繕部監修）に基づき施工する。

関係法令等 本工事については、次の関係法令その他の規定等に基づき施工すること。

- ・建築基準法、同施行令、同施行規則
- ・消防法、同施行令
- ・廃棄物の処理及び清掃に関する法律、同法施行令、同法施行規則
- ・労働安全衛生法、同法施行令、同法施行規則
- ・建設業法、同施行令、同施行規則
- ・建設工事公衆災害防止対策要綱
- ・石綿障害予防規則
- ・大気汚染防止法、振動規制法及び土壤汚染対策法
- ・建設工事に係る再資源化等に関する法律、同法施行令
- ・その他関係法令

疑義変更 本設計図書は、設計の大要を示すものであり、詳細部等について技術的必要事項は明記なくとも完全に施工すること。

施工に際して疑義が生じた場合、または軽微な変更を必要とする場合には、速やかに監理者と協議後、監督員の指示により施工すること。ただし、これらに於いて受注金額の増減はなきものとする。

本設計図書と不整合が確認されて設計変更（増額）が必要な場合は、その変更数量が確認できる根拠としての写真などの記録が存在し、かつ監督員に承認されたもの以外は認められない。

提出書類 施工に先立ち、工事工程表、仮設計画図及び監督員の指示する書類を提出し、監督員の承認を受けること。
商品名及び製造者名が記載された材料については、当該商品又は同等品を使用するものとし、同等品を使用する場合は、監督員の承諾を受けること。
設計図書に定める品質及び性能を有することについて、証明となる資料を提出して監督員の承諾を受けること。

工 期 本工事は請負契約締結の後、令和8年3月19日をもって工期とする。

このうち検査期間として13日間を見込んでいる。（工事の完成通知予定日は令和8年3月6日。）

留意事項

- ・図面に明示されていない事項であっても、工事上必要とされる事は工事範囲とする。
- ・入札に先立ち、現地調査を十分に行うこと。質疑がある場合は入札前に確認すること。
- ・図面について、設計者からの設計意図等の説明が必要な場合は申し出ること。
- ・作業日は、原則、月曜日から金曜日とし、土曜日及び日曜日は休工日とすること。
- ・行政機関の休日に関する法律（昭和63年法律第91号）に定める行政機関の休日に工事の施工を行わない。ただし、あらかじめ監督職員の承諾を受けた場合は、この限りではない。
- ・本工事は「発注者指定型」による週休2日適用工事の対象工事であり、「三原市週休2日適用工事等実施要領（建築工事）」（令和7年6月24日改定）により工事を行うこと。

- ・工事着手前までに「週休2日適用工事」または「週休2日交代制適用工事」に取り組むことを工事打合せ簿にて提出すること。
- ・「週休2日適用工事」または「週休2日交代制適用工事」である旨の表示を工事現場に設置すること。
- ・月単位の週休2日適用工事を達成できなくなった場合は、対象期間中の現場閉所（現場休息）の状況に応じた補正係数により労務費を減額する。
- ・本工事は居ながら工事を基本とし、必要に応じて保育士、園児等の通行制限を行うこととする。
工事の詳細については、事前に施設管理者等への説明を行って承諾を得ること。
- ・デジタル化を積極的に推進すること。
- ・紙資料の削減を目的として、電子機器の利用を主とすること。
- ・定例会の資料は、電子データを原則とすること。
- ・受注者は各定例会の前日までに必要な資料を所定の場所に提出すること。
- ・着手にあたり、工事着手前の周辺道路や近隣敷地の状況を写真等により記録しておくこと。
- ・近隣住民等の安全はもとより、丁寧な説明と施工により、関係者の理解と協力を得ながら実施すること。苦情等が発生した場合には誠意をもってこれに対応すること。
- ・近隣において、その他の工事が行われている場合は、取り合い工事及び工程等の調整を行うこと。
- ・近隣住民等への支障を最小限とするため、騒音・振動・粉塵等の対策については最大限配慮した施工方法を採用すること。
- ・使用する建設機械については、原則、「低騒音型、低振動型建設機械」として国土交通省の指定を受けた機械を選定して使用すること。これが確認できる資料を施工計画書で示すこと。なお、事情により使用が難しい場合は監督員との協議を行うこと。
- ・解体工事・アンカー工事等の騒音・振動・粉じん等の発生が予想される工種については、施工時間及び施工方法等を最大限配慮した計画により作業を行うこと。
- ・粉塵の発生が予想される工事は、確実に散水を行う等して、周辺環境への粉塵飛散がないように作業をすること。
- ・施工箇所周囲の備品・機器等については、粉塵対策として養生及び清掃等を確実に行うこと。養生や移動を行う場合は、事前に施設管理者または所有者に連絡すること。
- ・近隣家屋・敷地または周辺道路に対して、工事による汚れ・損傷・粉じん等を与えた場合は、受注者が責任をもって、速やかに清掃及び補修等を行うこと。誠意をもって対応し、現状復旧に努めること。
- ・周辺道路の保全及び清掃については常に注意を払って監視をし、定期的に清掃を行うこと。
- ・第三者災害防止及び飛散防止対策のために、必要に応じて監督員が指示する範囲にバリケード等を設置すること。
- ・工事車両の通行については、近隣住民及び保育士、園児等の安全を最優先すること。
- ・工事車両は、幅員の広い道路の通行を基本とし、住宅地内などの狭い道を抜け道として使用しないこと。工事車両の周辺の通行経路については、工事着手前に発注者の了承を得ること。
- ・場内に喫煙所を設ける場合は、施設使用者と近隣住民へ配慮し、設置位置と使用方法を協議してから設けること。使用方法を作業員に周知徹底すること。
- ・工事区域内の残置する設備配管・配線等については、事前に位置を確認してから作業を行うこと。事前調査記録を作成すること。
- ・受注者事務所、休憩所及び便所等は関係法令に従って設けること。
- ・図面等に示されている仮設等についても、必ず受注者で安全性や施工性等を検証すること。受注者が責任をもつて設置、施工すること。
- ・台風等の強風等異常気象が見込まれる場合は、事前に足場等の養生シートを折りたたむなど対策を施すこと。また、必要に応じて現場巡視と災害防止対策を行うこと。
- ・工事に係る電気、水道及び下水道料金等は受注者の負担とする。
- ・工事の要求に必要な仮設は、工事に含むものとする。
- ・重機が転倒しないように事前検討を行い、安全に作業を行うこと。
- ・石綿含有建材の調査（書面・目視調査、分析調査調査及び検体採取を含む）について、工事着手前までに一般建築物石綿含有建材調査者、または特定建築物石綿含有建材調査者が行うこと。
- ・その他石綿の飛散防止等については、改正大気汚染防止法及び施行令（令和3年4月1日施行）に基づくこと。
- ・石綿含有分析調査は試料採取と分析調査費を見込んでいる。分析は定性（JIS A 1481-1。含有の場合は、含有する層の判定も行う。）による。
- ・作業員に対して、新規入場教育時に石綿含有建材の使用位置を確認させること。
- ・石綿則に基づく事前調査のアスベスト分析マニュアル（最新版）に基づくこと。
- ・家電リサイクル法又はフロン排出抑制法に関する機器等の処分については、当該法律に基づき適正に行うこと。
- ・設備機器の固定については、「建築設備耐震設計・施工指針2014年版」の基準に基づいて検討し、監督員と協議の上、施工すること。


- ・道路使用申請等の工事に必要な各種手続きは、受注者の負担により遅滞なく行うこと。
- ・その他、工事に伴う官公庁等への手続きは、受注者により遅滞なく行うこと。この時、各種申請手数料等が発生した場合は受注者の負担とする。
- ・品質について、社内検査員(当該工事に従事していない者)を定め、設計図書に基づき社内検査を実施し、書類等の記録に残すこと。
- ・本工事の外注資材、労務等の調達については、極力、三原市内に主たる営業所を有する業者に発注すること。困難な場合は、あらかじめ理由を添えて発注者の承認を受けること。（理由については、三原市内に主たる業者に発注できない具体的な理由を明記すること。）
- ・広島県工事中情報共有システムを利用すること。なお、本工事にシステム利用料金を見込む。
- ・工事書類については、工事中情報共有システムの決裁データ等を整理して、CD-R又はDVD-Rにて提出すること。
- ・書面での提出が必要なもの（完成図書、建退共の掛金収納書、試験結果、保証書 等）については、PDFを工事中情報共有システムで提出し、別に書面提出ファイルとしてまとめて提出すること。
- ・製本図面（A3縮小版・二つ折り）として完成図を3部提出すること。
- ・以下の設計図面は、A2判をA3判に縮小している。（縮小率約70.7%）

本郷ひまわり保育園エアコン更新工事

| 番号 | 図面名 | 縮尺 |
|------|--------------------------|-------|
| M-00 | 表紙、図面リスト | ―― |
| M-01 | 機械設備特記仕様書（一般共通事項） | ―― |
| M-02 | 機械設備特記仕様書（工種別事項） | ―― |
| M-03 | 配置図 付近見取図 管種凡例 | 1/300 |
| M-04 | 空気調和設備 改修後 機器表 | ―― |
| M-05 | 空気調和設備 改修前後 系統図 | ―― |
| M-06 | 空気調和設備 改修後 1階平面詳細図(1) | 1/100 |
| M-07 | 空気調和設備 改修後 1階平面詳細図(2) | 1/100 |
| M-08 | 空気調和設備 改修後 屋上平面詳細図 | 1/100 |
| M-09 | 空気調和設備 改修前 機器表 | ―― |
| M-10 | 空気調和設備 改修前 1階平面詳細図(1) | 1/100 |
| M-11 | 空気調和設備 改修前 1階平面詳細図(2) | 1/100 |
| M-12 | 空気調和設備 改修前 屋上平面詳細図 | 1/100 |
| M-13 | 空調電源 改修後 1階・屋上平面図、受変電設備図 | 1/200 |
| M-14 | 空調電源 改修前 1階・屋上平面図、受変電設備図 | 1/200 |
| M-15 | (参考) 1階断面図 | 1/50 |
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| | | 株式会社 設備計画 代表取締役 呼坂政明 | 工事名 本郷ひまわり保育所エアコン更新工事 | 縮尺 - | 図面番号 M / 00 |
| | | | 図面名 表紙、図面リスト | | |

| 工事概要等 | |
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| 1. 工事場所 三原市下北方1丁目 | |
| 2. 建物概要 | |
| <table border="1"> <tr> <td>建物名稱</td> <td>構造</td> <td>階数</td> <td>建築基準法による延べ面積(m²)</td> <td>消防法施行令別表第一の区分</td> <td>備考</td> <td></td> </tr> <tr> <td>本郷ひまわり保育所</td> <td>鉄筋コンクリート造</td> <td>地上1階建て</td> <td>1,474.03</td> <td>6項-(二)</td> <td>既存</td> <td></td> </tr> </table> | | | | | | | 建物名稱 | 構造 | 階数 | 建築基準法による延べ面積(m ²) | 消防法施行令別表第一の区分 | 備考 | | 本郷ひまわり保育所 | 鉄筋コンクリート造 | 地上1階建て | 1,474.03 | 6項-(二) | 既存 | |
| 建物名稱 | 構造 | 階数 | 建築基準法による延べ面積(m ²) | 消防法施行令別表第一の区分 | 備考 | |
| 本郷ひまわり保育所 | 鉄筋コンクリート造 | 地上1階建て | 1,474.03 | 6項-(二) | 既存 | |
| 3. 工事種目 (○印の付いたものを適用する) | |
| <table border="1"> <tr> <th>建物別及び屋外</th> <th colspan="3">工事種類</th> <th colspan="3">種別</th> </tr> <tr> <td>工事種目</td> <td>こども園</td> <td></td> <td></td> <td>屋外</td> <td></td> <td></td> </tr> <tr> <td>○空気調和設備</td> <td>改設一式</td> <td></td> <td></td> <td></td> <td></td> <td></td> </tr> <tr> <td>・換気設備</td> <td></td> <td></td> <td></td> <td></td> <td></td> <td></td> </tr> <tr> <td>・排煙設備</td> <td></td> <td></td> <td></td> <td></td> <td></td> <td></td> </tr> <tr> <td>・自動制御設備</td> <td></td> <td></td> <td></td> <td></td> <td></td> <td></td> </tr> <tr> <td>・衛生器具設備</td> <td></td> <td></td> <td></td> <td></td> <td></td> <td></td> </tr> <tr> <td>・給水設備</td> <td></td> <td></td> <td></td> <td></td> <td></td> <td></td> </tr> <tr> <td>・排水設備</td> <td></td> <td></td> <td></td> <td></td> <td></td> <td></td> </tr> <tr> <td>・給湯設備</td> <td></td> <td></td> <td></td> <td></td> <td></td> <td></td> </tr> <tr> <td>・消火設備</td> <td></td> <td></td> <td></td> <td></td> <td></td> <td></td> </tr> <tr> <td>・ガス設備</td> <td></td> <td></td> <td></td> <td></td> <td></td> <td></td> </tr> <tr> <td>・厨房設備</td> <td></td> <td></td> <td></td> <td></td> <td></td> <td></td> </tr> <tr> <td>・淨化槽設備</td> <td></td> <td></td> <td></td> <td></td> <td></td> <td></td> </tr> <tr> <td>・雨水利用設備</td> <td></td> <td></td> <td></td> <td></td> <td></td> <td></td> </tr> <tr> <td>・特殊ガス設備</td> <td></td> <td></td> <td></td> <td></td> <td></td> <td></td> </tr> <tr> <td>・電気設備工事</td> <td>電気設備工事の部による</td> <td></td> <td></td> <td></td> <td></td> <td></td> </tr> <tr> <td>・建築工事</td> <td>建築工事の部による</td> <td></td> <td></td> <td></td> <td></td> <td></td> </tr> </table> | | | | | | | 建物別及び屋外 | 工事種類 | | | 種別 | | | 工事種目 | こども園 | | | 屋外 | | | ○空気調和設備 | 改設一式 | | | | | | ・換気設備 | | | | | | | ・排煙設備 | | | | | | | ・自動制御設備 | | | | | | | ・衛生器具設備 | | | | | | | ・給水設備 | | | | | | | ・排水設備 | | | | | | | ・給湯設備 | | | | | | | ・消火設備 | | | | | | | ・ガス設備 | | | | | | | ・厨房設備 | | | | | | | ・淨化槽設備 | | | | | | | ・雨水利用設備 | | | | | | | ・特殊ガス設備 | | | | | | | ・電気設備工事 | 電気設備工事の部による | | | | | | ・建築工事 | 建築工事の部による | | | | | |
| 建物別及び屋外 | 工事種類 | | | 種別 | |
| 工事種目 | こども園 | | | 屋外 | |
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| ・雨水利用設備 | |
| ・特殊ガス設備 | |
| ・電気設備工事 | 電気設備工事の部による | |
| ・建築工事 | 建築工事の部による | |
| 4. 指定部分 無し 有り(工期令和年月日) 対象部分: | |
| 5. 設備概要 (改修の場合は既存の概要を示す。) | |
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| 排煙設備 | 自動制御方式(・電気式・電子式・デジタル式) | |
| 給水方式 | 水道直結・高置タンク・ポンプ直送・水道直結増圧 | |
| 排水方式 | 建物内の污水と雑排水(・合流・分流) ポンプ排水(・有・汚水・雑排水・湧水)・無 | |
| 放流水 | 直放流水管・浄化槽 直放流水管・浄化槽・側溝・別途井 | |
| 排水管 | (計画容量:m ³)・無 | |
| 設置設備 | 有(・局所式・中央式)・無 熟源(・電気・都市ガス・液化石油ガス・灯油・A重油) 室内消火栓・連結送水管・屋外消火栓・スプリンクラー | |
| 備蓄設備 | 有(・合併処理・小規模合併処理)・無 | |
| 6. 工事仕様 | |
| 1. 共通仕様 | |
| 1) 特記事項及び図面に記載されていない事項は、国土交通省大臣官房官房営繕部の標準仕様書等による。ただし、○印の付いたものを適用する。 | |
| ○ 公共建築工事標準仕様書(機械設備工事編)令和4年版(以下「標準仕様書」という。) | |
| ・公共建築改修工事標準仕様書(機械設備工事編)令和4年版(以下「改修標準仕様書」という。) | |
| ○ 公共建築設備工事標準図(機械設備工事編)令和4年版(以下「標準図」という。) | |
| 2) 電気設備工事及び建築工事を本工事に含む場合、電気設備工事及び建築工事はそれぞれの特記事項書を適用する。 | |
| 2. 特記仕様 | |
| 1) 項目は、番号に印の付いたものを適用する。 | |
| 2) 特記事項のうち選択する事項は○印の付いたものを適用する。 | |
| ただし、○印のない場合は印を適用する。 | |
| ○印○印の場合は共に適用する。 | |
| 区分 | 項目 | 特記事項 | |
| 一般共通事項 | ⑥環境への配慮 | 1) 国等による環境物品等の調達の推進等に関する法律(グリーン購入法)に基づき策定された「広島県グリーン購入方針」に掲載されている品目においては、他の特記事項及び図面表記の範囲内で、環境負荷を低減できる材料を優先的に選定するよう努めるものとする。 | |
| | 2) 建築物内部に使用する材料等は、設計図書に規定する所要の品質及び性能を有すると共に、次のからを満たすものとする。 合板、木質系フローリング、構造用パネル、集成材、单板積層材、MDF、パーティクルボード、その他の木質建材、コリア樹脂板、壁紙、接着剤、保溫材、緩衝材、断熱材、塗料、仕上塗料は、アセトアルデヒド及びスチレンを発散しない又は発散が極めて少ない材料を使用する。 接着剤は、可塑性(フタル酸ジ-n-ブチル及びフタル酸ジ-2-エチルヘキシル等を含有しない難揮発性の可塑剤を除く)が添加されていない材料を使用する。 の材料を使用して作られた家具、書架、実験台、その他の什器類は、ホルムアルデヒド、アセトアルデヒド及びスチレンを発散しないか、発散が極めて少ない材料を使用したものとする。 | |
| | 3) 建築物の品質等 | |
| | 4) 機材の品質等 | |
| | 5) 機材の承諾図 | |
| | 6) 圖形表示 | |
| | 7) 容量等の表示 | |
| | 8) 技能士の適用 | |
| | 9) 化学物質の濃度測定 | |
| | 10) 合成ゴム製の取扱い | |
| 11) インバーター用制御及び操作盤 | |
| 12) 総合試運転調整 | |
| 13) 分岐 | |
| 14) 伸縮管継手 | |
| 15) 絶縁継手 | |
| 16) スリーブ形 | |
| 17) ポリテトラフルオロエチレン樹脂製 | |
| 18) ベローズ形(ステンレス製) | |
| 19) フラッシュ接合 | |
| 20) 電線類 | |
| 21) 配管の建物導入部 | |
| 22) ステンレス鋼管の接合方法 | |
| 23) ピニール管の接合方法 | |
| 24) ポリエチレン管の接合方法 | |
| 25) 溶接配管の検査 | |
| 26) 異種管の接続 | |
| 27) 支持金物・固定金具 | |
| 28) 埋設表示 | |
| 29) 保溫 | |
| 30) 塗装 | |
| 31) 足場 | |
| 32) 工事用電力、水、その他 | |
| 33) 監督職員事務所 | |
| 34) 工事用仮設物 | |
| 35) 土工事 | |
| 36) コンクリート工事 | |
| 37) あと施工アンカーカー | |
| 38) 耐震施工 | |
| 39) 電線類 | |
| 40) 施工調査 | |
| 41) 撤去工事 | |
| 42) 非破壊検査 | |
| 43) 他工事との取合い | |
| 44) 天井仕上区分 | |
| 45) 完成時の提出書類等 | |
| 46) 撤去する配管、ダクト(付属品含む)の保溫材は、配管・ダクト等により分離する。 | |
| 47) 下記の部分を除き、原則として塗装(標準仕様書第2編3.2による)を行う。 亜鉛めっきされたもので、常時隠えられる部分、金属電線管、鋼製架台及び支持金物類、主・各階機械室内等及び電気室内の亜鉛めっきされた露出ダクト及び露出配管、カラー亜鉛鉄板面、亜鉛めっき以外のめっき仕上げ面、樹脂コーティング等を施したもので、常時隠えられる部分アルミニウム、ステンレス、銅、溶融アルミニウム・亜鉛鉄板、合成樹脂等、特に塗装の必要を認められない面、埋設されるもの。 (ただし、防食塗装部分を除く) | |
| 48) 電子納品 | |
| 49) 工事中情報共有システム | |
| 50) 施工計画書 | |
| 51) 履行報告 | |
| 52) 建設廃棄物の処理 | |
| 53) 優先順位 | |
| 54) 官公署その他への手続き等 | |
| 55) 別契約の関係工事との協調 | |
| 56) 調査への対応 | |
| 57) 工事現場の表示 | |
| 58) 交通誘導員 | |
| 59) 説明板等 | |
| 60) 前期調査(監督員に報告書を提出すること。) | |
| 61) 調査内容 | |
| 62) 調査範囲 | |
| 63) 調査方法 | |
| 64) 撤去する配管、ダクト(付属品含む)の保溫材は、配管・ダクト等により分離する。 | |
| 65) はつり工事及び穿孔作業を行う場合は、事前に非破壊検査を行い、監督職員に報告する。原則、探査方法は走査式埋設物調査(電磁誘導法または電磁波レーダ法)とする。 | |
| 66) 放射線透過検査等による埋設物の調査を実施する場合、範囲は監督職員の指示による。放射線透過検査の検査費は別途とする。 | |
| 67) 図面に特記のない場合は別紙「工事区分表」による。 | |
| 68) 電気設備工事、建築工事等との合併工事の場合は工事区分とする。 | |
| 69) ()書きの室名は天井無しを示し、その他は天井ありを示す。 | |
| 70) ()完成図面は天井無しを示し、その他は天井ありを示す。 | |
| 71) ()完成図面(A4版) | |
| 72) ()完成図面(A4版) | |
| 73) ()完成図面(A4版) | |
| 74) ()完成図面(A4版) | |
| 75) ()完成図面(A4版) | |
| 76) ()完成図面(A4版) | |
| 77) ()完成図面(A4版) | |
| 78) ()完成図面(A4版) | |
| 79) ()完成図面(A4版) | |
| 80) ()完成図面(A4版) | |
| 81) ()完成図面(A4版) | |
| 82) ()完成図面(A4版) | |
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| 185) ()完成図面(A4版) | |
| 186) ()完成図面(A4版) | |
| 187) ()完成図面(A4版) | |
| 188) ()完成図面(A4版) | |
| 189) ()完成図面(A4版) | |
| 190) ()完成図面(A4版) | |
| 191) ()完成図面(A4版 | |


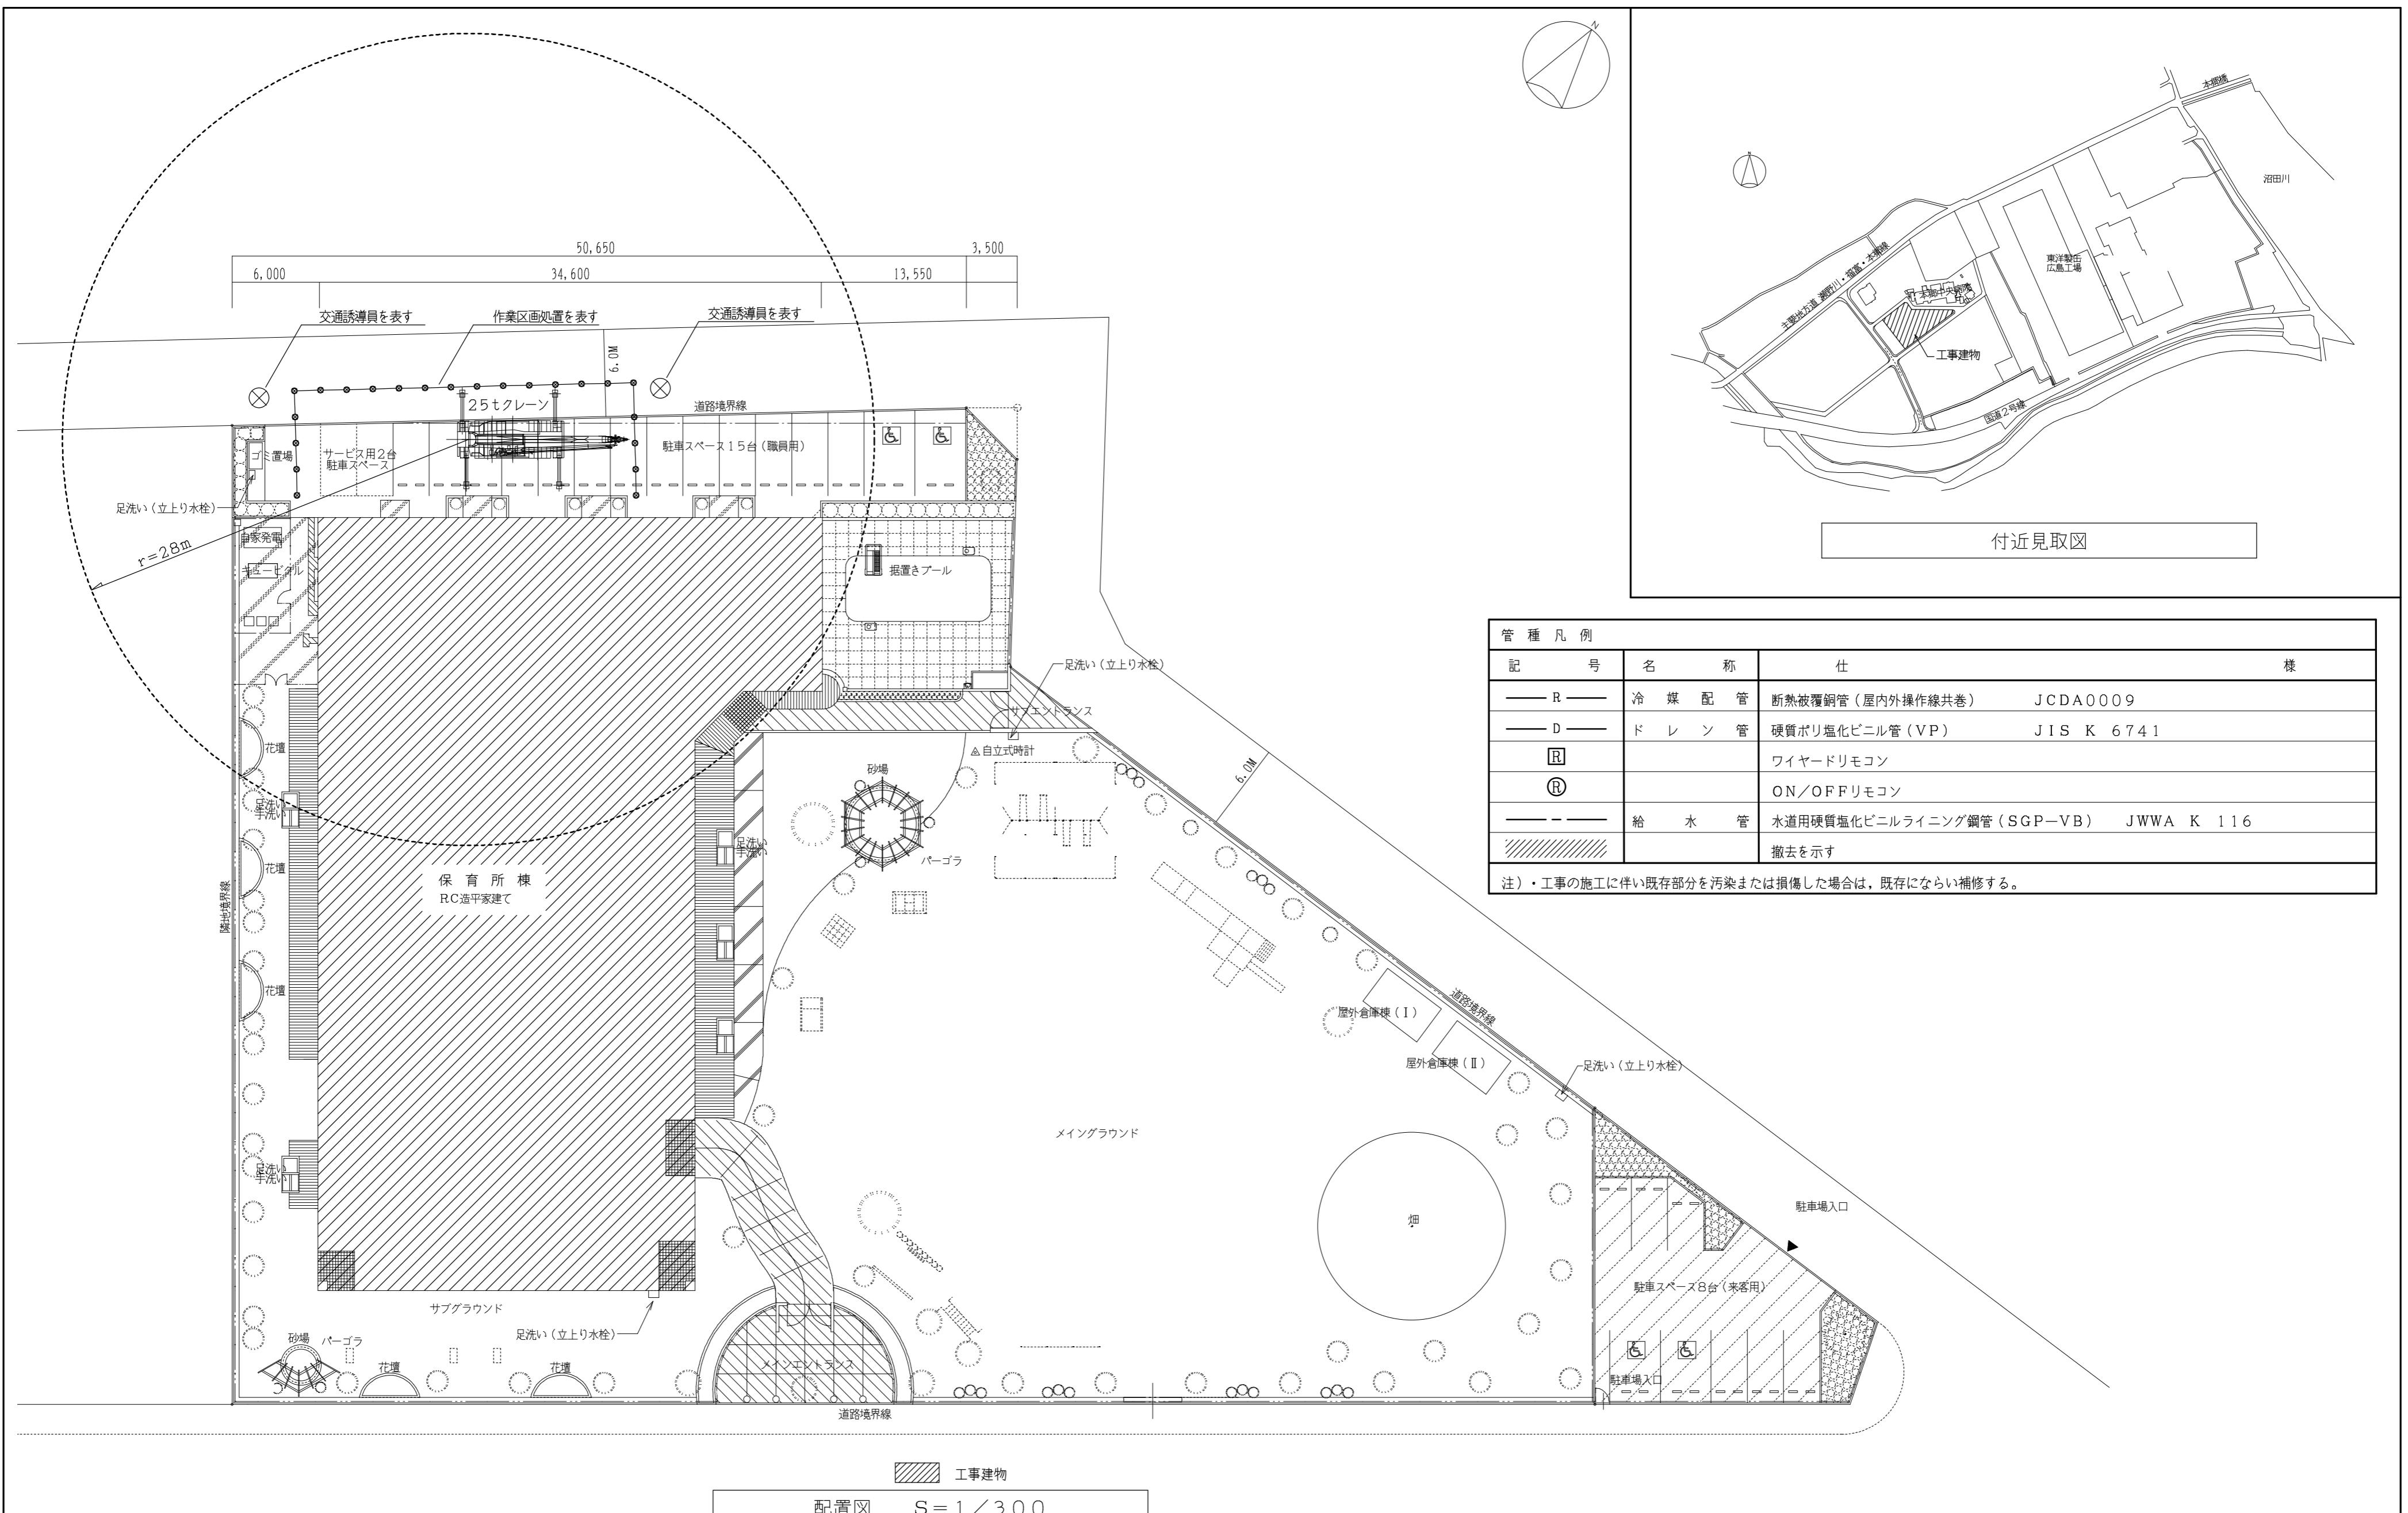


| | | | |
|-----|-------------------|------|---------|
| 工事名 | 本郷ひまわり保育所エアコン更新工事 | 縮尺 | S=1/300 |
| 図面名 | 配置図 付近見取図 管種凡例 | 図面番号 | M 03 |

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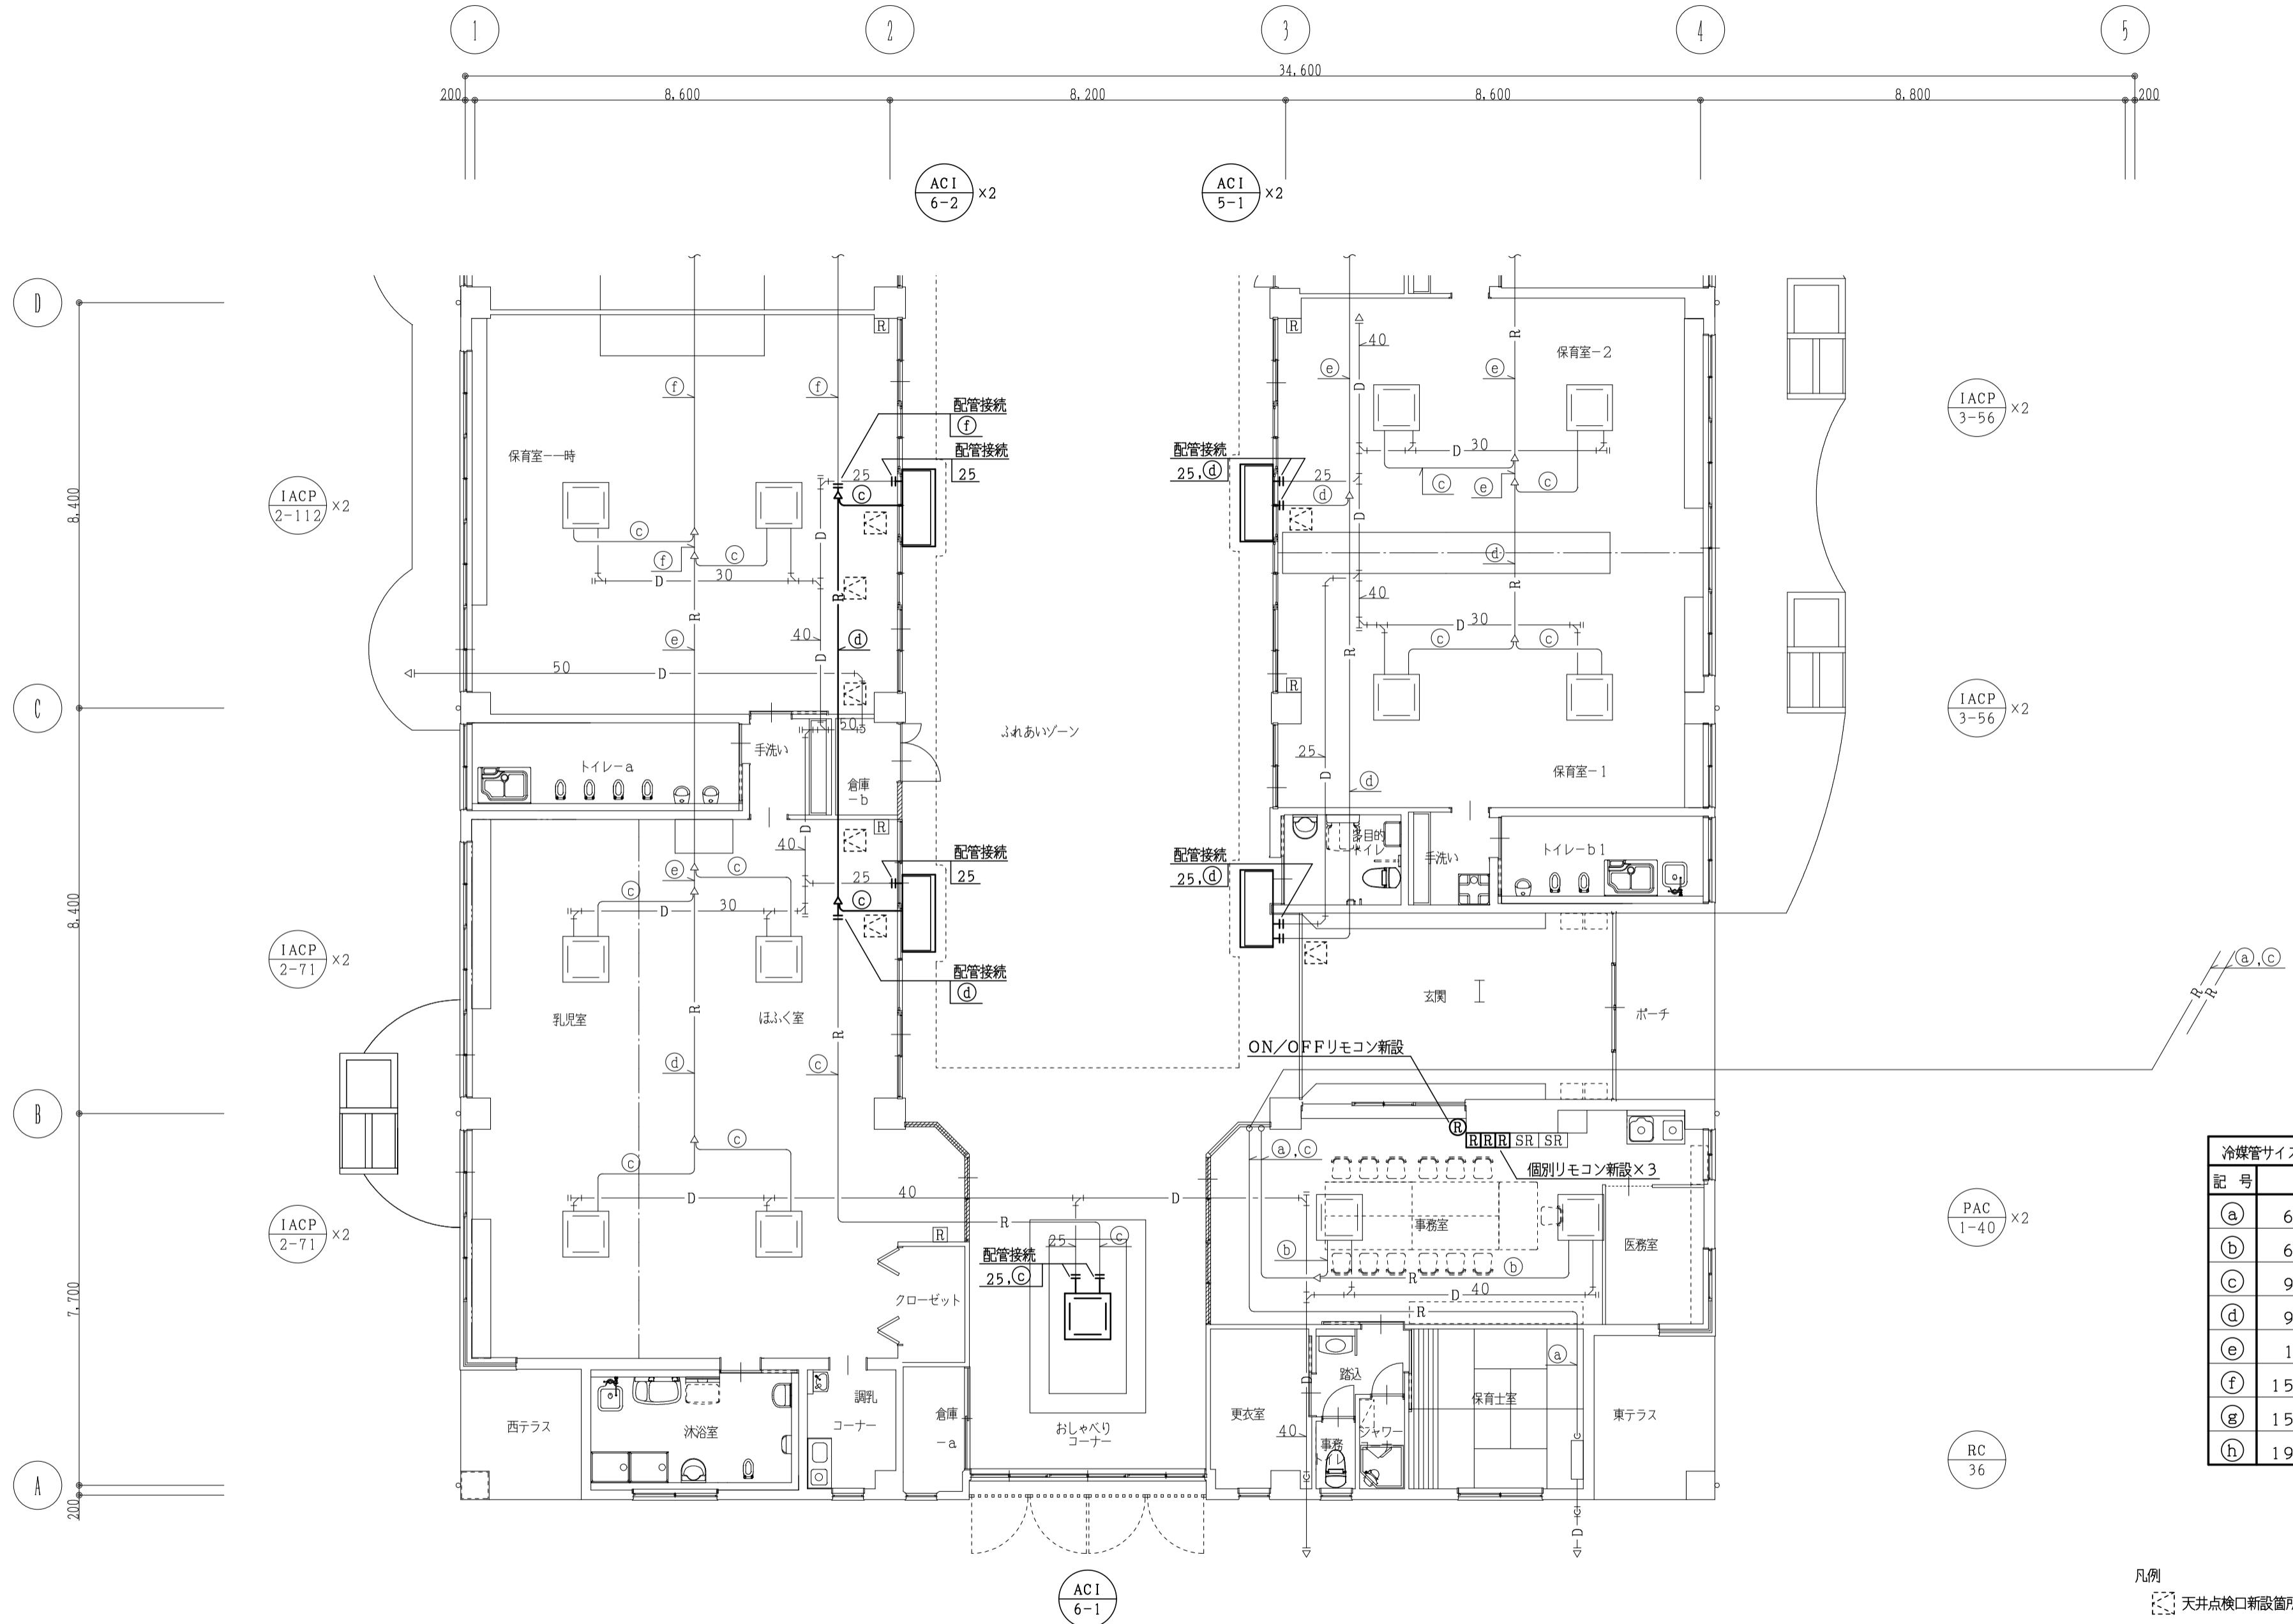
| 機器表 | | | | | | | | | | |
|---------|--------------|-----------------------------|----|-----|--------|----|-----------|---------|--------------|--|
| 記号 | 名称 | 仕様 | 電源 | | | 台数 | 設置場所 | 機器表 | | |
| | | | φ | V | kW | | | 記号 | 名称 | 仕様 |
| ACP-5 | マルチエアコン（屋外機） | 型式：空冷ヒートポンプマルチエアコン、インバーター制御 | | | | 1 | 屋上 屋外機置場 | ACP-7 | マルチエアコン（屋外機） | 型式：空冷ヒートポンプマルチエアコン、インバーター制御 |
| | | 冷暖切替運転型 | | | | | | | | 冷暖切替運転型 |
| | | 冷房能力：56.0kW | | | | | | | | 冷房能力：56.0kW |
| | | 暖房能力：63.0kW | | | | | | | | 暖房能力：63.0kW |
| | | 圧縮機： | 3 | 200 | 16.5 | | | | | 圧縮機： |
| | | 送風機： | 3 | 200 | 0.72×2 | | | | | 送風機： |
| | | 付属品：スプリング防振架台、外機渡り分岐管 | | | | | | | | 付属品：スプリング防振架台、外機渡り分岐管 |
| | | 他標準付属品一式共 | | | | | | | | 他標準付属品一式共 |
| | | 【参考型番】ダイキン RQYP560FC | | | | | | | | 【参考型番】ダイキン RQYP560FC |
| ACI-5-1 | マルチエアコン（屋内機） | 型式：空冷ヒートポンプマルチエアコン | | | | 3 | ふれあいゾーン | ACI-7-1 | マルチエアコン（屋内機） | 型式：空冷ヒートポンプマルチエアコン |
| | | 天吊形 | | | | | | | | 天井埋込カセット形（4方向吹出） |
| | | 冷房能力：14.0kW | 1 | 200 | 0.127 | | | | | 冷房能力：8.0kW |
| | | 暖房能力：16.0kW | 1 | 200 | 0.182 | | | | | 暖房能力：9.0kW |
| | | 送風機： | 1 | 200 | 0.3 | | | | | 送風機： |
| | | 付属品：昇降パネル、昇降リモコン | | | | | | | | 付属品：昇降パネル、昇降リモコン、ドレンアップメカ |
| | ワイヤードリモコン | 【参考型番】ダイキン FXYHP140NB | | | | | | | | 防振吊金具 他標準付属品一式 |
| | | | | | | | | | | 【参考型番】ダイキン FXYFP80NB |
| ACP-6 | マルチエアコン（屋外機） | 型式：空冷ヒートポンプマルチエアコン、インバーター制御 | | | | 1 | 事務室 | ACI-7-2 | マルチエアコン（屋内機） | 型式：空冷ヒートポンプマルチエアコン |
| | | 冷暖切替運転型 | | | | | | | | 天吊形 |
| | | 冷房能力：56.0kW | 1 | 200 | 0.127 | | | | | 冷房能力：14.0kW |
| | | 暖房能力：63.0kW | 1 | 200 | 0.182 | | | | | 暖房能力：16.0kW |
| | | 送風機： | 1 | 200 | 0.3 | | | | | 送風機： |
| | | 付属品：スプリング防振架台、外機渡り分岐管 | | | | | | | | 付属品：昇降パネル、昇降リモコン |
| | | 他標準付属品一式共 | | | | | | | | 【参考型番】ダイキン FXYHP140NB |
| | | 【参考型番】ダイキン RQYP560FC | | | | | | | | |
| | | | | | | | | | | |
| ACI-6-1 | マルチエアコン（屋内機） | 型式：空冷ヒートポンプマルチエアコン | | | | 1 | おしゃべりコーナー | | | 特記事項 |
| | | 天井埋込カセット形（4方向吹出） | | | | | | | | 1.・マルチエアコンはメーカー仕様とする。 |
| | | 冷房能力：5.6kW | 1 | 200 | 0.052 | | | | | 2.・マルチエアコンの能力表示はJIS条件による。（JIS B 8616） |
| | | 暖房能力：6.3kW | 1 | 200 | 0.038 | | | | | 3.・使用する冷媒はR410A又はR32とする。 |
| | | 送風機： | 1 | 200 | 0.053 | | | | | 4.・冷媒管（保温共）、操作線は製造者標準品とし、適所に共巻きを行う。 |
| | | 付属品：昇降パネル、昇降リモコン、ドレンアップメカ | | | | | | | | 5.・冷媒配管の屋外露出部はステンレスラッキングとする。 |
| | | 防振吊金具 他標準付属品一式 | | | | | | | | 6.・電気容量は参考値とする。また、機器の1次側電源接続線は電気工事とする。 |
| | | 【参考型番】ダイキン FXYFP56NB | | | | | | | | 7.・電源線、操作線はメーカー標準品とし、屋外露出部はステンレスラッキング内に共巻きする。 |
| ACI-6-2 | マルチエアコン（屋内機） | 型式：空冷ヒートポンプマルチエアコン | | | | 3 | ふれあいゾーン | | | 8.・マルチエアコンの冷房能力50.4kW以下の機器はグリーン購入法適合品とする。 |
| | | 天吊形 | | | | | | | | 9.・屋内機は、支持部（天井スラブ等）と機器固定部間に振止めを4面に設けること。（標準仕様書による、天井埋込カセット形のみ） |
| | | 冷房能力：14.0kW | 1 | 200 | 0.127 | | | | | 10.・原則、本工事で使用するアンカーはねじアンカー（立管支持を除く）とし、屋内機用のアンカーは、ねじアンカー（ウェッジ式）とする。 |
| | | 暖房能力：16.0kW | 1 | 200 | 0.182 | | | | | 11.・あと施工アンカー（屋外機）の引抜試験を行う事。 |
| | | 送風機： | 1 | 200 | 0.3 | | | | | 12.・高調波規制と特定需要家ガイドラインに基づき高調波対策を行うものとする。 |
| | | 付属品：昇降パネル、昇降リモコン | | | | | | | | 13.・図面上ふれあいゾーンの配管切断接続箇所は保育室側で図示してあるが、施工方法を限定するものではない。钢管のフレアを再利用はしないこと。 |
| | | 【参考型番】ダイキン FXYHP140NB | | | | | | | | 14.・機器撤去後の不要なアンカー等は切断後銷止め処理を行なうこと。 |
| | | | | | | | | | | 15.ON/OFFリモコン配線について採用するメーカーにより配線状況を施工前に調査を行ない、監督員と協議すること。 |
| | ワイヤードリモコン | | | | | | | | | |

| 工事名 本郷ひまわり保育所エアコン更新工事 | | | | 縮尺 | 図面番号 |
|-----------------------|--|--|--|--------------------|--------|
| 代表取締役 呼坂政明 | | | | 図面名 空気調和設備 改修後 機器表 | M / 04 |

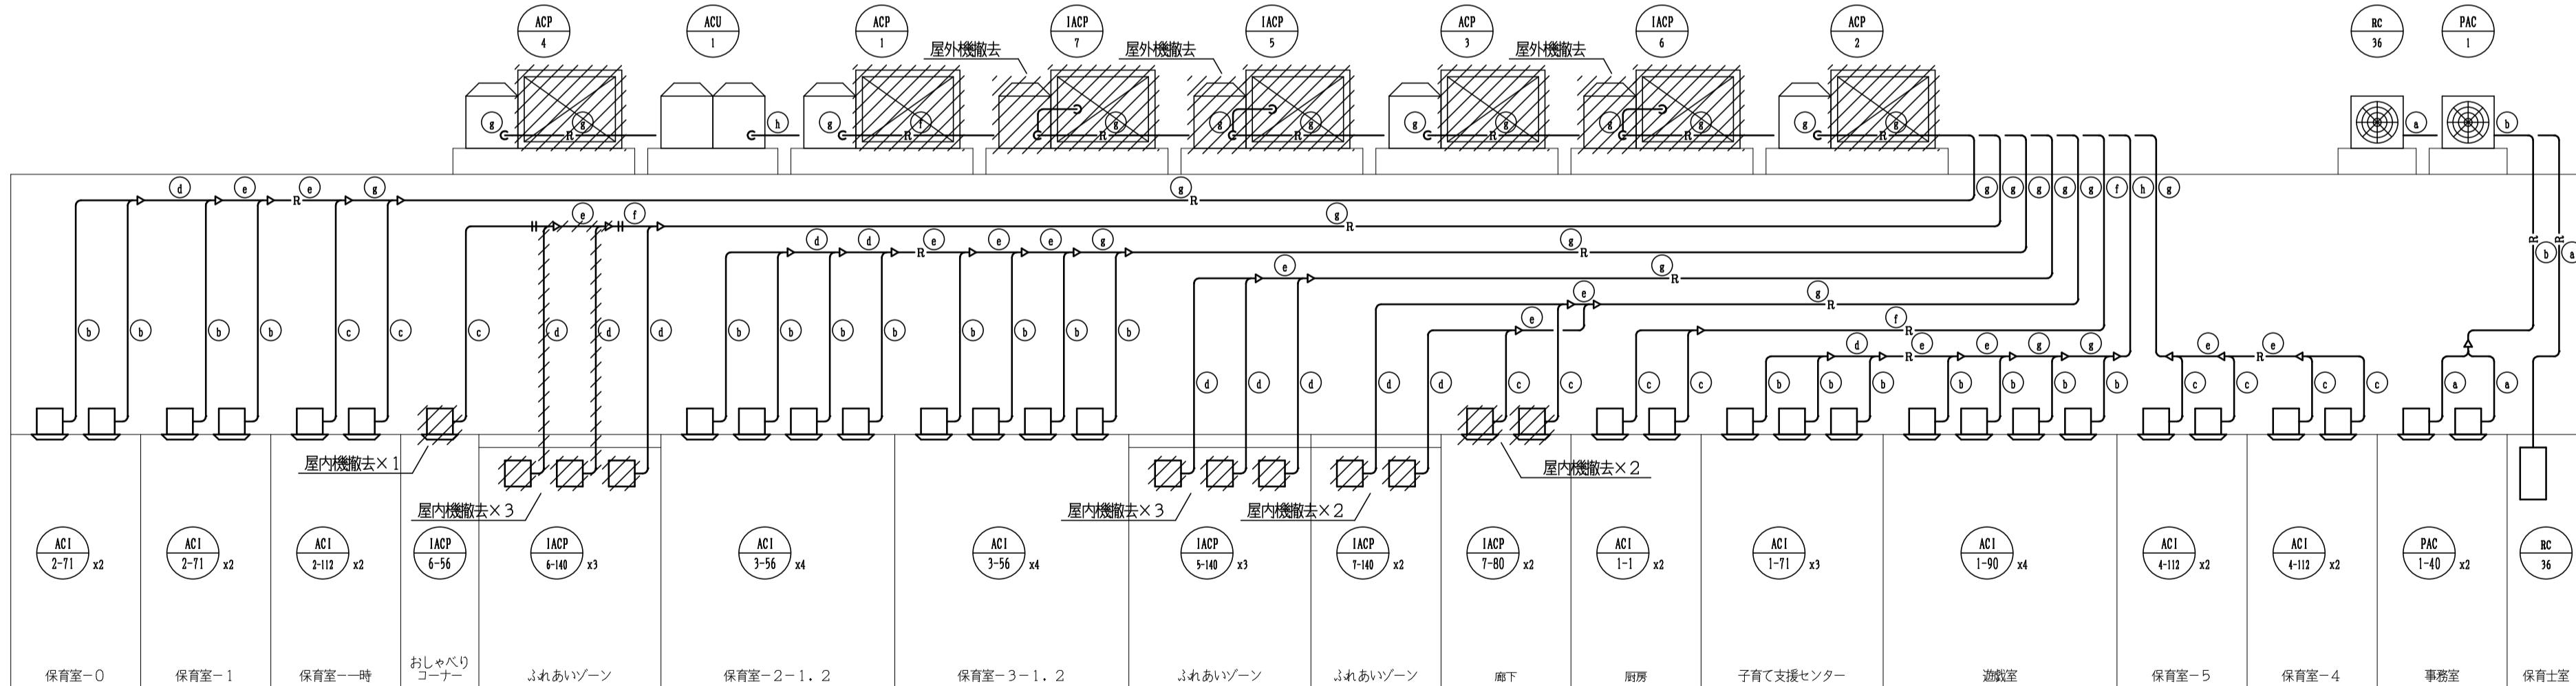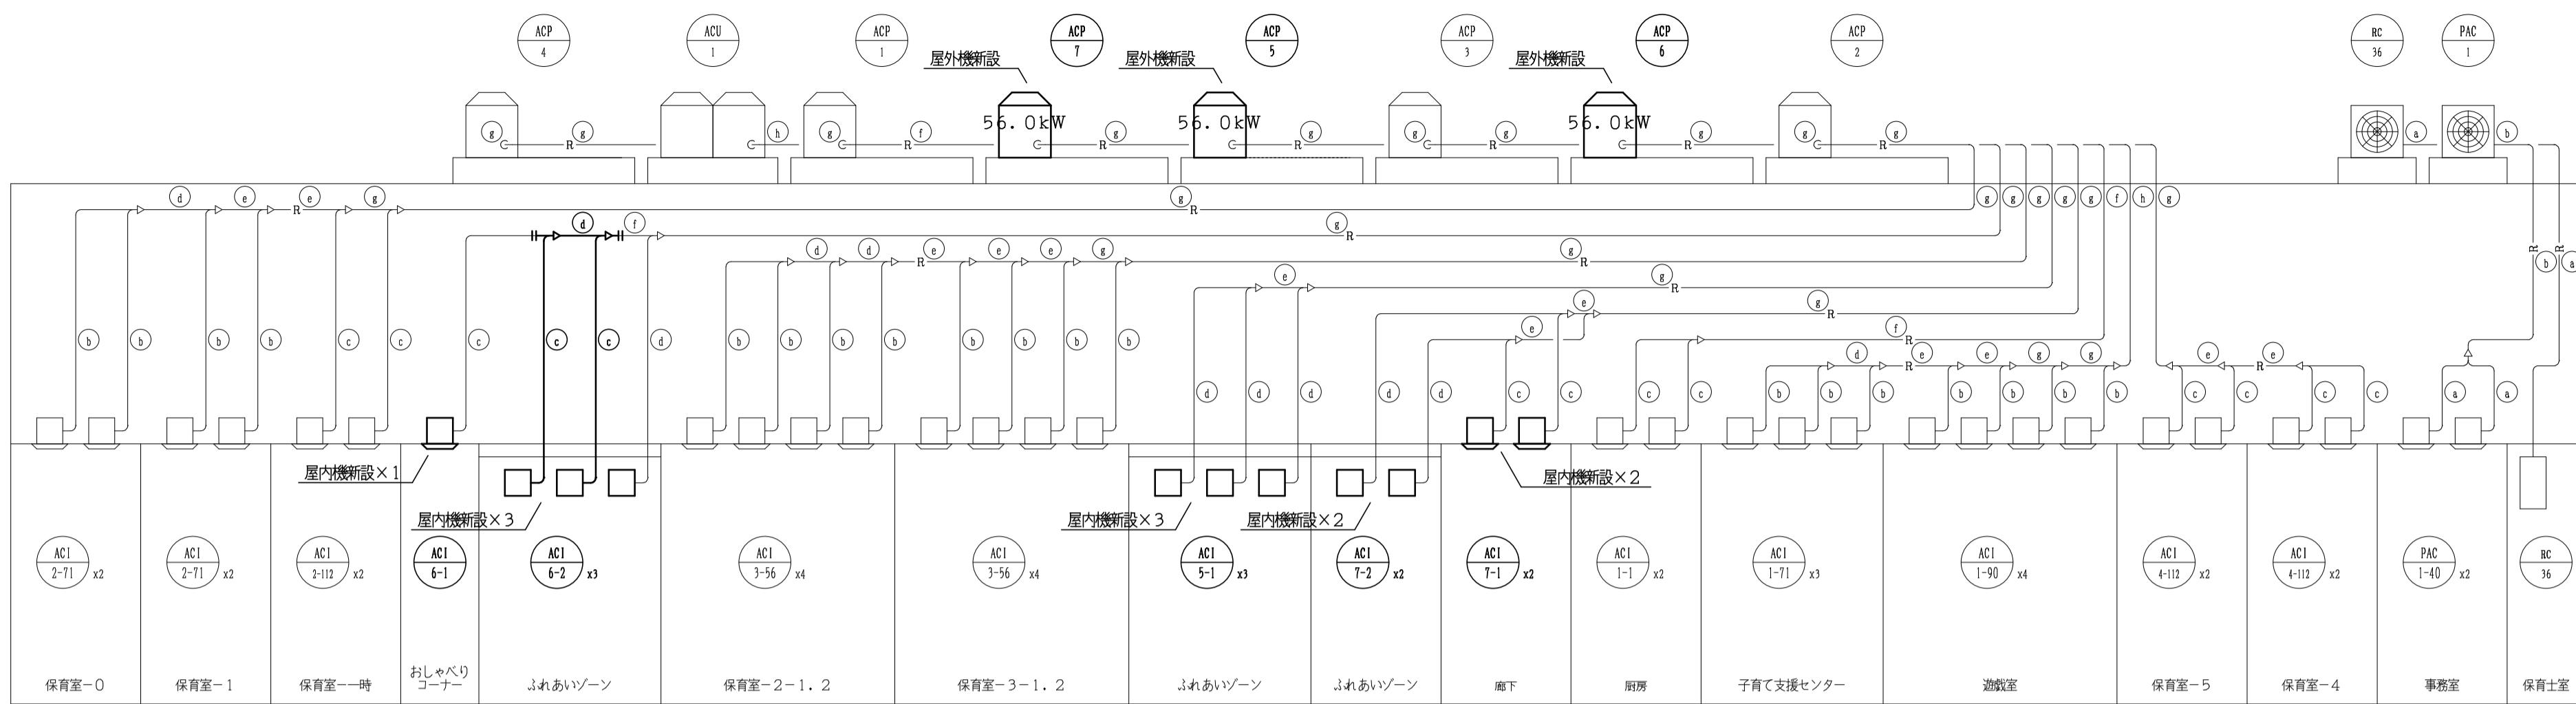


改修前 系統図

| | | | | | |
|--|--|--------------|-----------------------|------|--------|
| | | 株式会社 設 備 計 画 | 工事名 本郷ひまわり保育所エアコン更新工事 | 縮尺 - | 図面番号 M |
| | | 代表取締役 呼坂政明 | 図面名 空気調和設備 改修前後 系統図 | | 05 |




| | | | |
|-----|-----------------------|----|--|
| 工事名 | 本郷ひまわり保育所エアコン更新工事 | 縮尺 | |
| 図面名 | 空気調和設備 改修後 1階平面詳細図(1) | | |

M
06

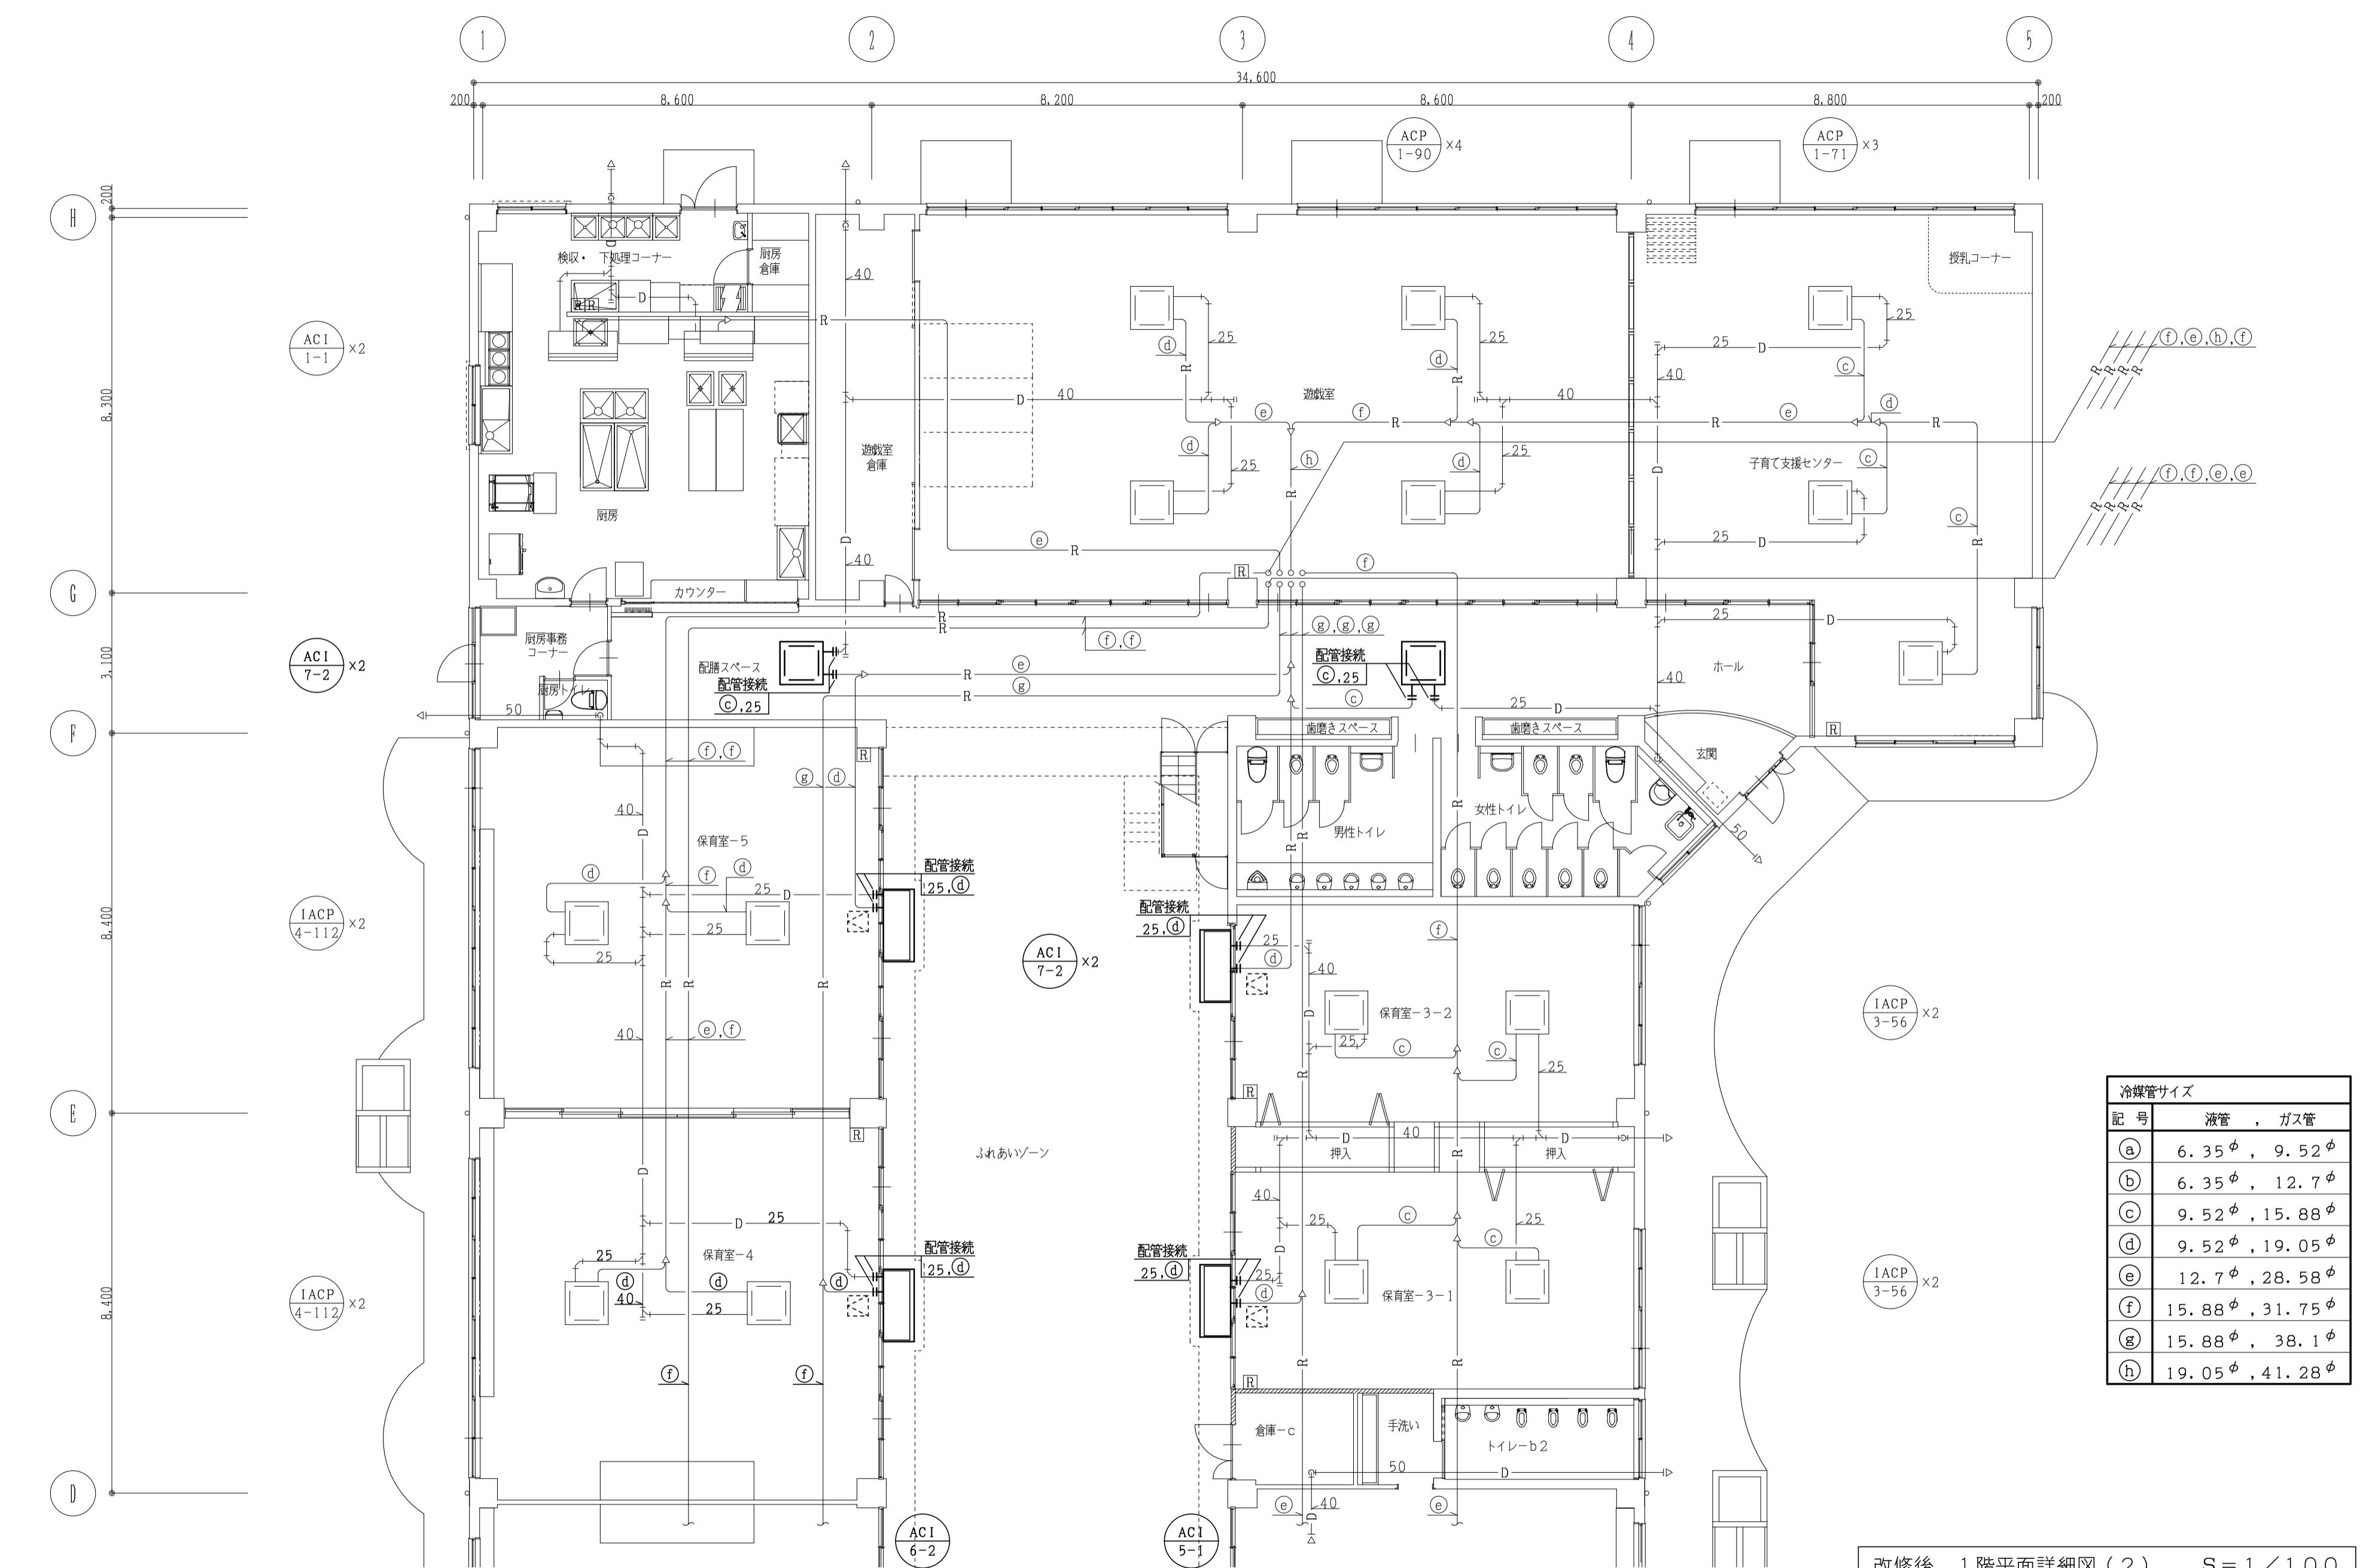

| | | | |
|-----|-----------------------|----|----|
| 工事名 | 本郷ひまわり保育所エアコン更新工事 | 縮尺 | |
| 図面名 | 空気調和設備 改修後 1階平面詳細図(2) | M | 07 |

株式会社 設備計画
代表取締役 呼坂政明

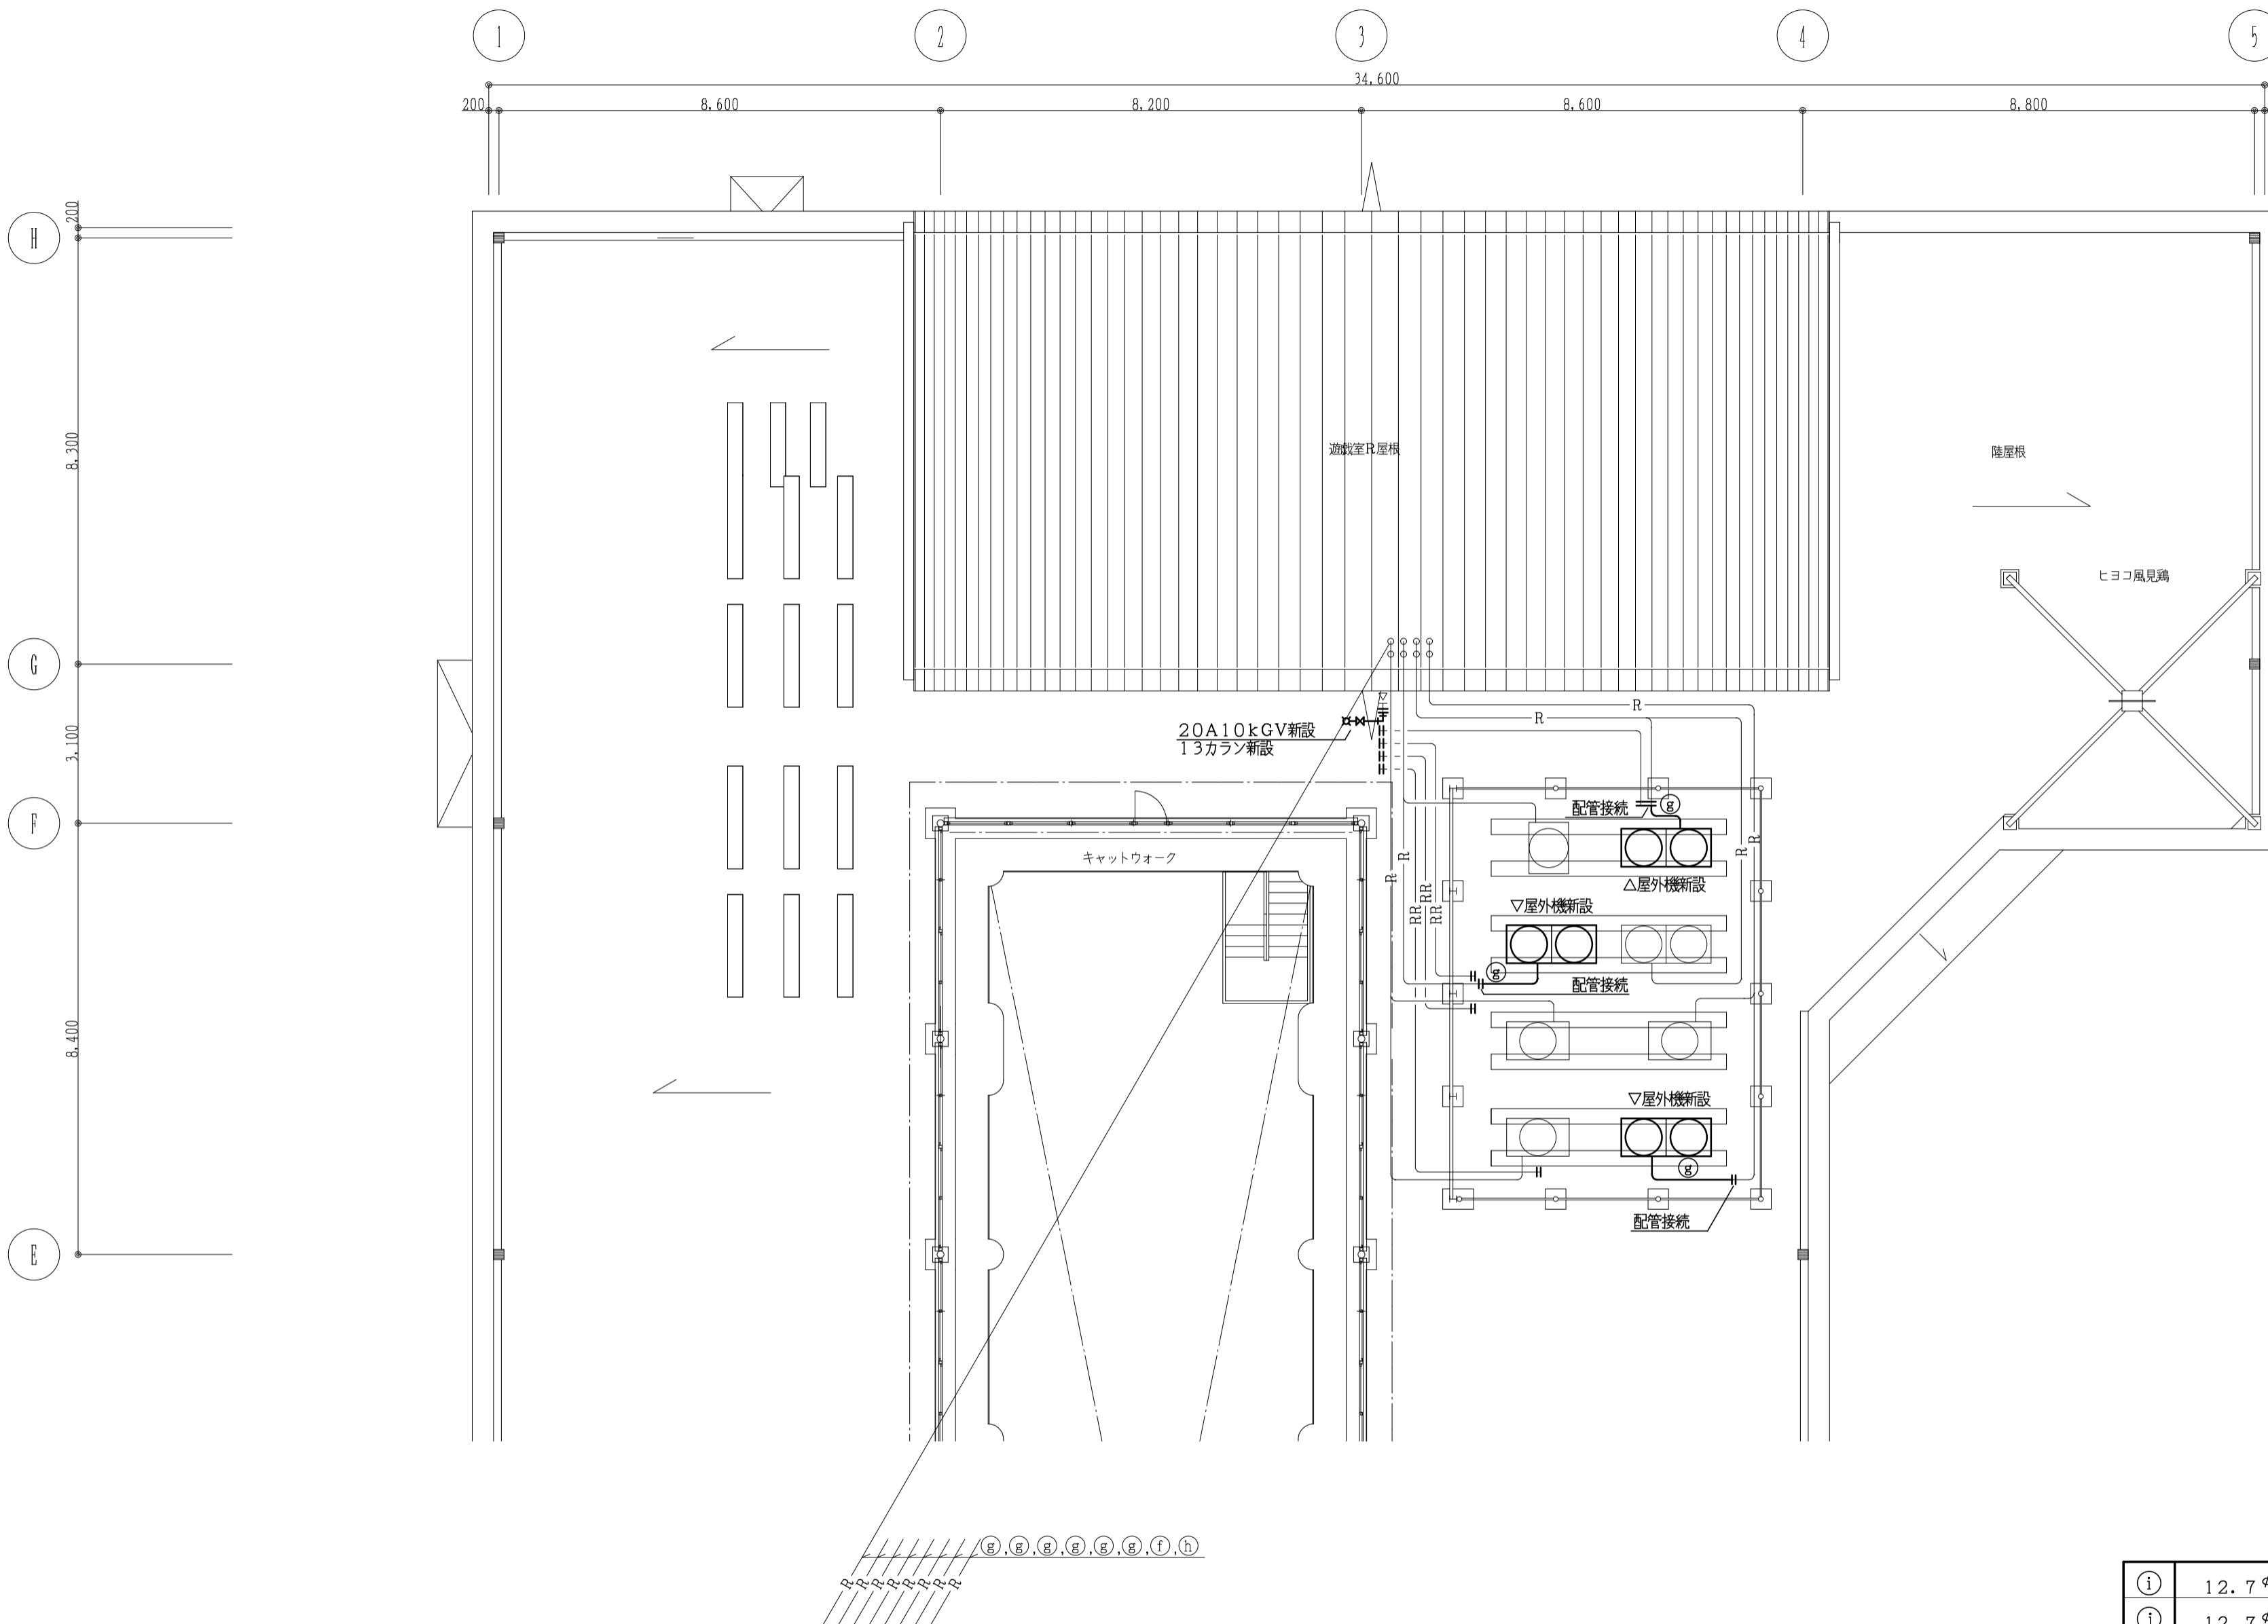


注・) 図示している屋上の冷媒配管については現地のラッキングで抱き合せている組合せで図示している。

改修後 屋上平面詳細図

S = 1 / 100


| | | | | | | | |
|--|--|--------------|-----|--------------------|----|---|--------|
| | | | 工事名 | 本郷ひまわり保育所エアコン更新工事 | 縮尺 | - | 図面番号 |
| | | 株式会社 設 備 計 画 | 図面名 | 空気調和設備 改修後 屋上平面詳細図 | | | M / 08 |
| | | 代表取締役 呼坂政明 | | | | | |

| 機器表 | | | | | | | |
|------------|----------------------|------------------------------------|-----|-----|------|-----|-----------|
| 記号 | 名 称 | 仕 様 | 電 源 | | | 台 数 | 設 置 場 所 |
| | | | φ | V | kW | | |
| IACP-5 | 氷蓄熱ビル用マルチエアコン 屋外機 | 型 式 : ピークシフトタイプ | 3 | 200 | 10.7 | 1 | 屋上 屋外機置場 |
| | | 冷房能力: 45.0kW(蓄熱利用) 33.5kW(非蓄熱利用) | | | | | |
| | | 暖房能力: 45.0kW(蓄熱利用) 38.7kW(非蓄熱利用) | | | | | |
| | | 冷 媒 : R407C (17.0kg) | | | | | |
| | | 屋 外 機 : (寸法) 2050×883×1318 (464kg) | | | | | |
| | | 付属品 : 防振架台, 蓄熱リモコン, タイマーキット | | | | | |
| | | 三洋電機 : SPW-CHKP450U1 | | | | | |
| | | | | | | | |
| IACP-5-140 | 氷蓄熱ビル用マルチエアコン 屋内機 | 型 式 : 天吊形 | | | | 3 | ふれあいゾーン |
| | | 冷房能力: 14.0kW | 1 | 200 | 0.24 | | |
| | | 暖房能力: 16.0kW | | | | | |
| | | | | | | | |
| IACP-6 | 氷蓄熱ビル用マルチエアコン 屋外機 | 型 式 : ピークシフトタイプ | 3 | 200 | 10.7 | 1 | 事務室 |
| | | 冷房能力: 45.0kW(蓄熱利用) 33.5kW(非蓄熱利用) | | | | | |
| | | 暖房能力: 45.0kW(蓄熱利用) 38.7kW(非蓄熱利用) | | | | | |
| | | 冷 媒 : R407C (17.0kg) | | | | | |
| | | 屋 外 機 : (寸法) 2050×883×1318 (464kg) | | | | | |
| | | 付属品 : 防振架台, 蓄熱リモコン, タイマーキット | | | | | |
| | | 三洋電機 : SPW-CHKP450U1 | | | | | |
| | | | | | | | |
| IACP-6-56 | 氷蓄熱ビル用マルチエアコン 屋内機 | 型 式 : 天井カセット形(4方向吹出) | | | | 1 | おしゃべりコーナー |
| | | 冷房能力: 5.6kW | 1 | 200 | 0.12 | | |
| | | 暖房能力: 6.3kW | | | | | |
| | | | | | | | |
| IACP-6-140 | 氷蓄熱ビル用マルチエアコン 屋内機 | 型 式 : 天吊形 | | | | 3 | ふれあいゾーン |
| | | 冷房能力: 14.0kW | 1 | 200 | 0.24 | | |
| | | 暖房能力: 16.0kW | | | | | |
| | | | | | | | |
| IACP-7 | 氷蓄熱ビル用マルチエアコン 屋外機 | 型 式 : ピークシフトタイプ | | | | 1 | 屋上 屋外機置場 |
| | | 冷房能力: 45.0kW(蓄熱利用) 33.5kW(非蓄熱利用) | | | | | |
| | | 暖房能力: 45.0kW(蓄熱利用) 38.7kW(非蓄熱利用) | | | | | |
| | | 冷 媒 : R407C (17.0kg) | | | | | |
| | | 屋 外 機 : (寸法) 2050×883×1318 (464kg) | | | | | |
| | | 付属品 : 防振架台, 蓄熱リモコン, タイマーキット | | | | | |
| | | 三洋電機 : SPW-CHKP450U1 | | | | | |
| | | | | | | | |
| IACP-7-80 | 氷蓄熱ビル用マルチエアコン 屋内機 | 型 式 : 天井カセット形(4方向吹出) | | | | 2 | 廊下 |
| | | 冷房能力: 8.0kW | | | | | |
| | | 暖房能力: 9.0kW | | | | | |
| | | | | | | | |
| IACP-7-140 | 氷蓄熱ビル用マルチエアコン 屋内機 | 型 式 : 天吊形 | | | | 2 | ふれあいゾーン |
| | | 冷房能力: 14.0kW | | | | | |
| | | 暖房能力: 16.0kW | | | | | |
| | | | | | | | |
| IACP-8 | ワイヤードリモコン | 型 式 : ピークシフトタイプ | | | | 1 | 事務室 |
| | | 冷房能力: 45.0kW(蓄熱利用) 33.5kW(非蓄熱利用) | | | | | |
| | | 暖房能力: 45.0kW(蓄熱利用) 38.7kW(非蓄熱利用) | | | | | |
| | | 冷 媒 : R407C (17.0kg) | | | | | |
| IACP-9 | 氷蓄熱ユニット | 型 式 : 天井カセット形(4方向吹出) | | | | 6 | 屋上 屋外機置場 |
| | | 冷房能力: 1255×2000×2240 (600kg) | | | | | |
| | | 暖房能力: 1255×2000×2240 (600kg) | | | | | |
| | | | | | | | |
| IACP-10 | 氷蓄熱槽 | 型 式 : 天井カセット形(4方向吹出) | | | | 1 | 屋上 屋外機置場 |
| | | 冷房能力: 1255×2000×2240 (600kg) | | | | | |
| | | 暖房能力: 1255×2000×2240 (600kg) | | | | | |
| | | | | | | | |
| IACP-11 | 氷蓄熱槽 | 型 式 : 天井カセット形(4方向吹出) | | | | 1 | 屋上 屋外機置場 |
| | | 冷房能力: 1255×2000×2240 (600kg) | | | | | |
| | | 暖房能力: 1255×2000×2240 (600kg) | | | | | |
| | | | | | | | |
| IACP-12 | 氷蓄熱槽 | 型 式 : 天井カセット形(4方向吹出) | | | | 1 | 屋上 屋外機置場 |
| | | 冷房能力: 1255×2000×2240 (600kg) | | | | | |
| | | 暖房能力: 1255×2000×2240 (600kg) | | | | | |
| | | | | | | | |
| IACP-13 | 氷蓄熱槽 | 型 式 : 天井カセット形(4方向吹出) | | | | 1 | 屋上 屋外機置場 |
| | | 冷房能力: 1255×2000×2240 (600kg) | | | | | |
| | | 暖房能力: 1255×2000×2240 (600kg) | | | | | |
| | | | | | | | |
| IACP-14 | 氷蓄熱槽 | 型 式 : 天井カセット形(4方向吹出) | | | | 1 | 屋上 屋外機置場 |
| | | 冷房能力: 1255×2000×2240 (600kg) | | | | | |
| | | 暖房能力: 1255×2000×2240 (600kg) | | | | | |
| | | | | | | | |
| IACP-15 | 氷蓄熱槽 | 型 式 : 天井カセット形(4方向吹出) | | | | 1 | 屋上 屋外機置場 |
| | | 冷房能力: 1255×2000×2240 (600kg) | | | | | |
| | | 暖房能力: 1255×2000×2240 (600kg) | | | | | |
| | | | | | | | |
| IACP-16 | 氷蓄熱槽 | 型 式 : 天井カセット形(4方向吹出) | | | | 1 | 屋上 屋外機置場 |
| | | 冷房能力: 1255×2000×2240 (600kg) | | | | | |
| | | 暖房能力: 1255×2000×2240 (600kg) | | | | | |
| | | | | | | | |
| IACP-17 | 氷蓄熱槽 | 型 式 : 天井カセット形(4方向吹出) | | | | 1 | 屋上 屋外機置場 |
| | | 冷房能力: 1255×2000×2240 (600kg) | | | | | |
| | | 暖房能力: 1255×2000×2240 (600kg) | | | | | |
| | | | | | | | |
| IACP-18 | 氷蓄熱槽 | 型 式 : 天井カセット形(4方向吹出) | | | | 1 | 屋上 屋外機置場 |
| | | 冷房能力: 1255×2000×2240 (600kg) | | | | | |
| | | 暖房能力: 1255×2000×2240 (600kg) | | | | | |
| | | | | | | | |
| IACP-19 | 氷蓄熱槽 | 型 式 : 天井カセット形(4方向吹出) | | | | 1 | 屋上 屋外機置場 |
| | | 冷房能力: 1255×2000×2240 (600kg) | | | | | |

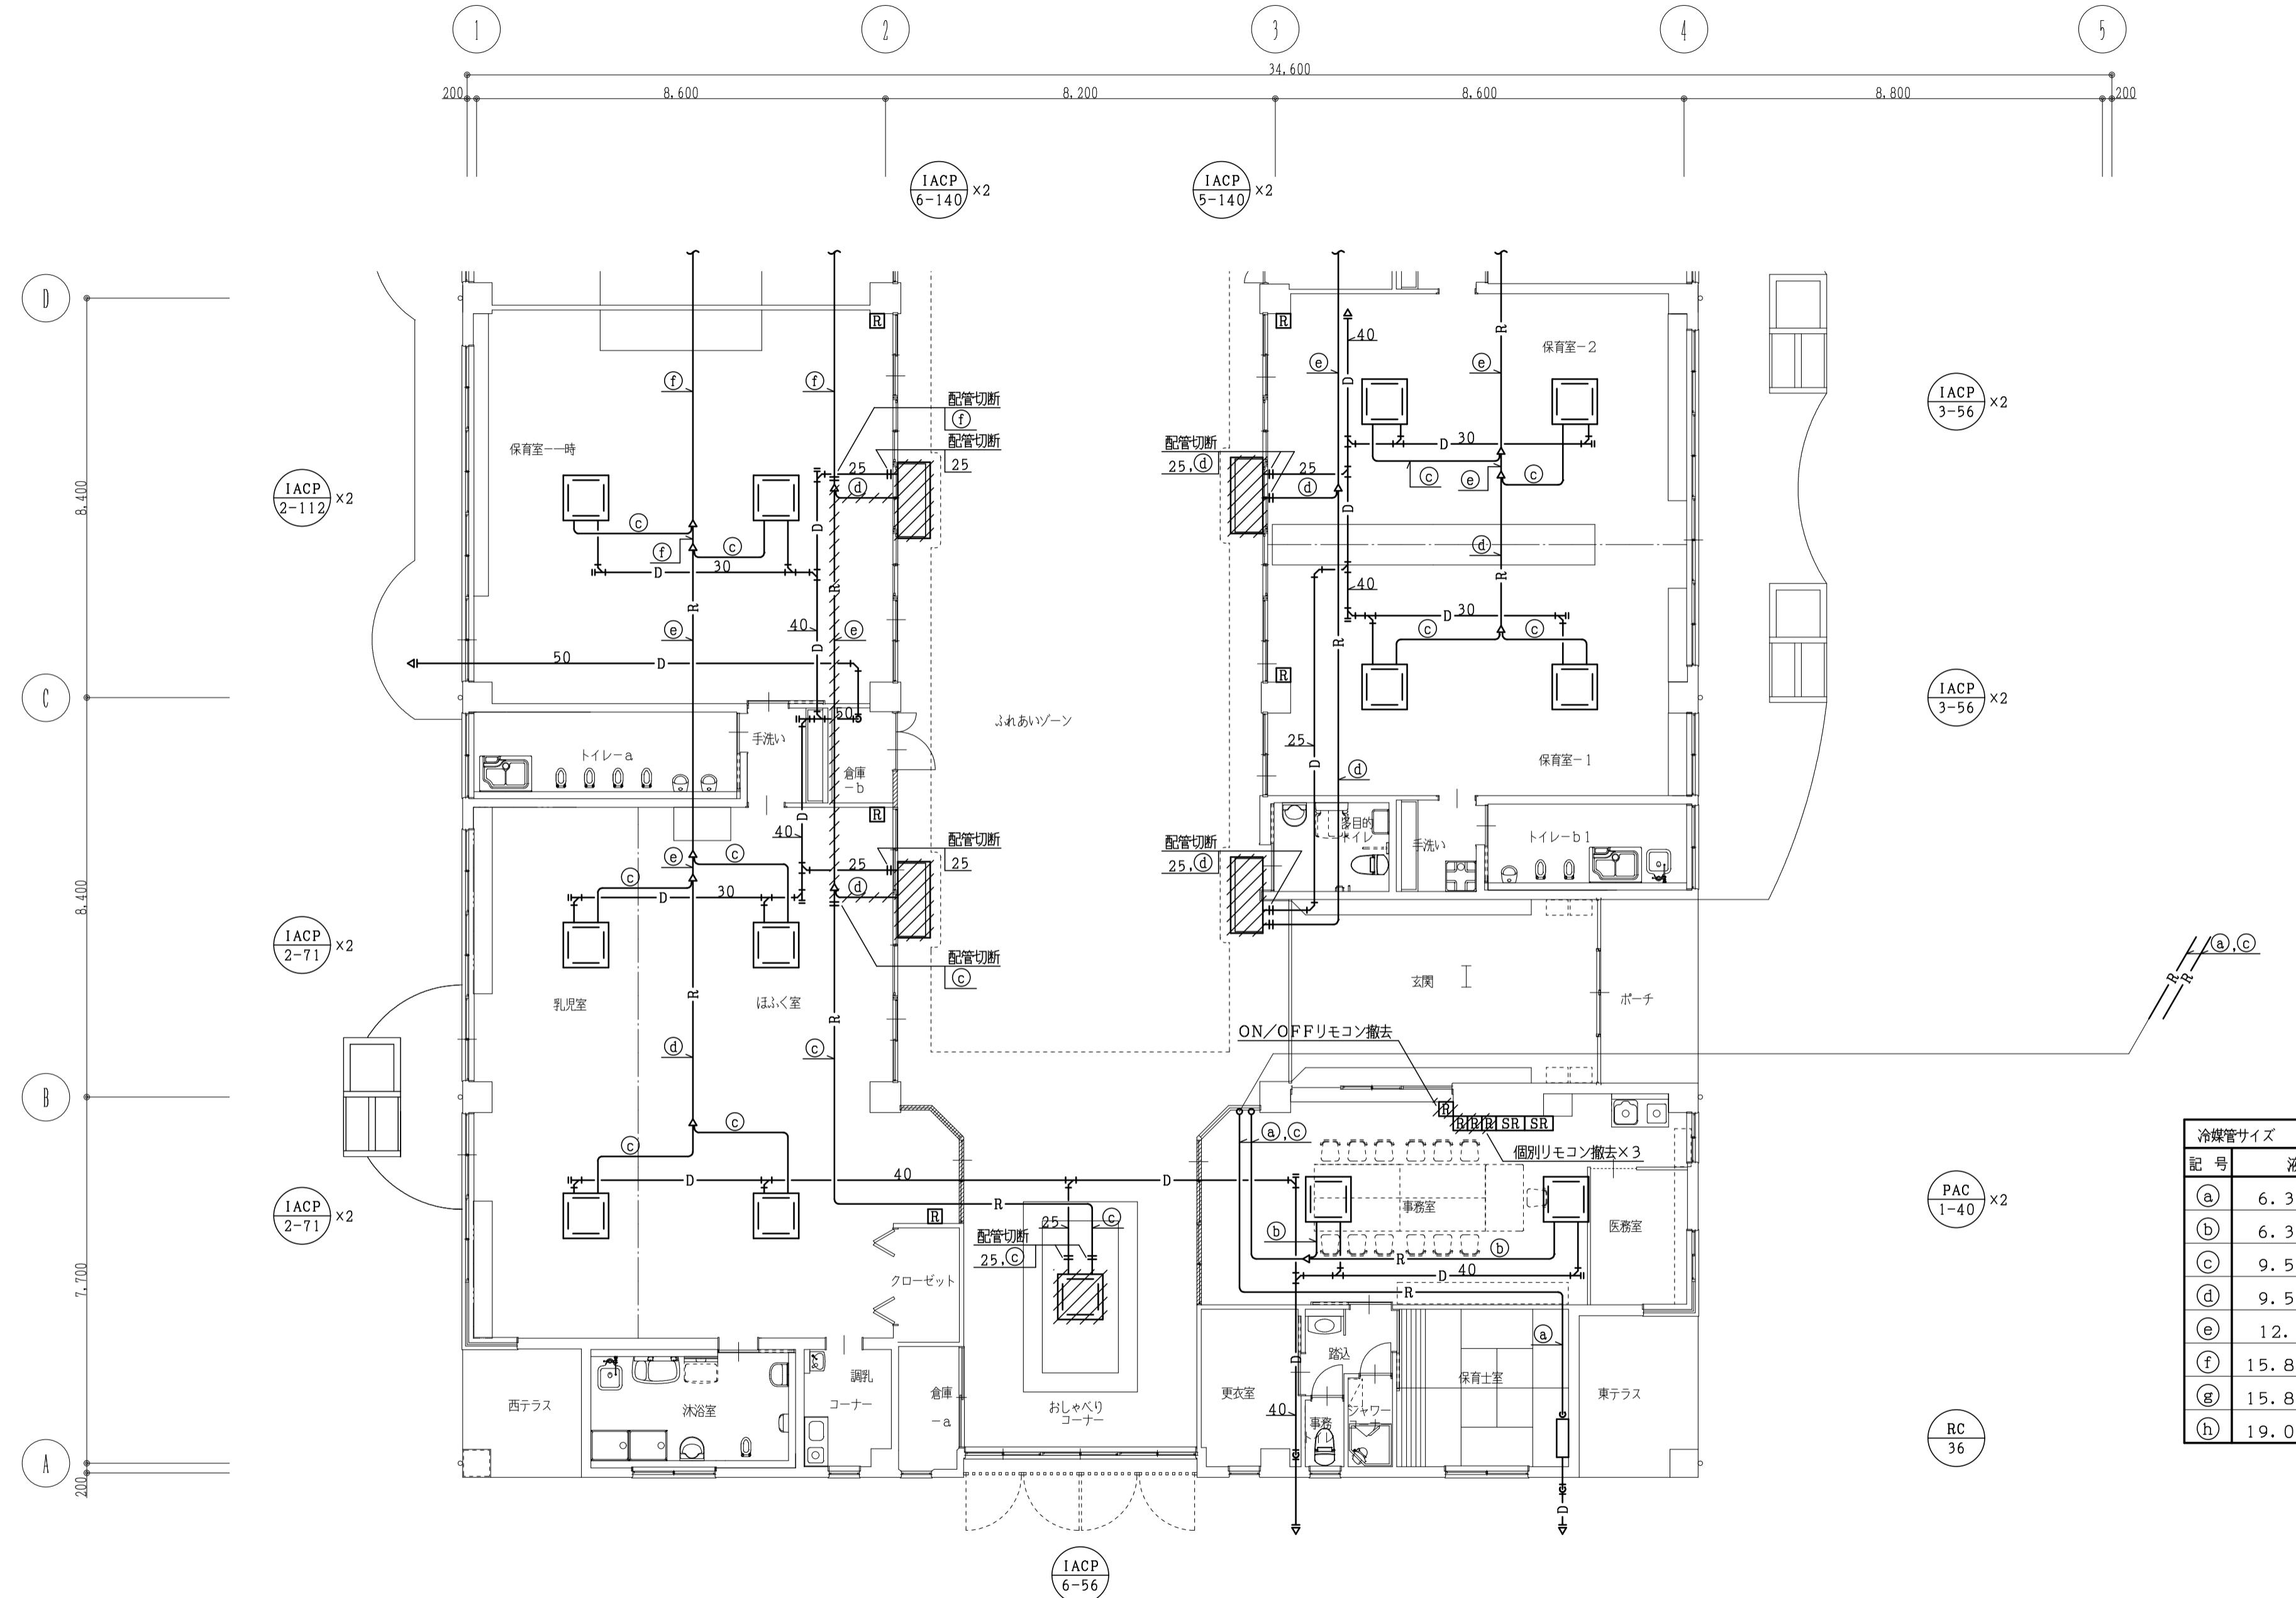


改修前 1階平面詳細図(1) S=1/100

| | | | |
|-----|-----------------------|----|--|
| 工事名 | 本郷ひまわり保育所エアコン更新工事 | 縮尺 | |
| 図面名 | 空気調和設備 改修前 1階平面詳細図(1) | | |

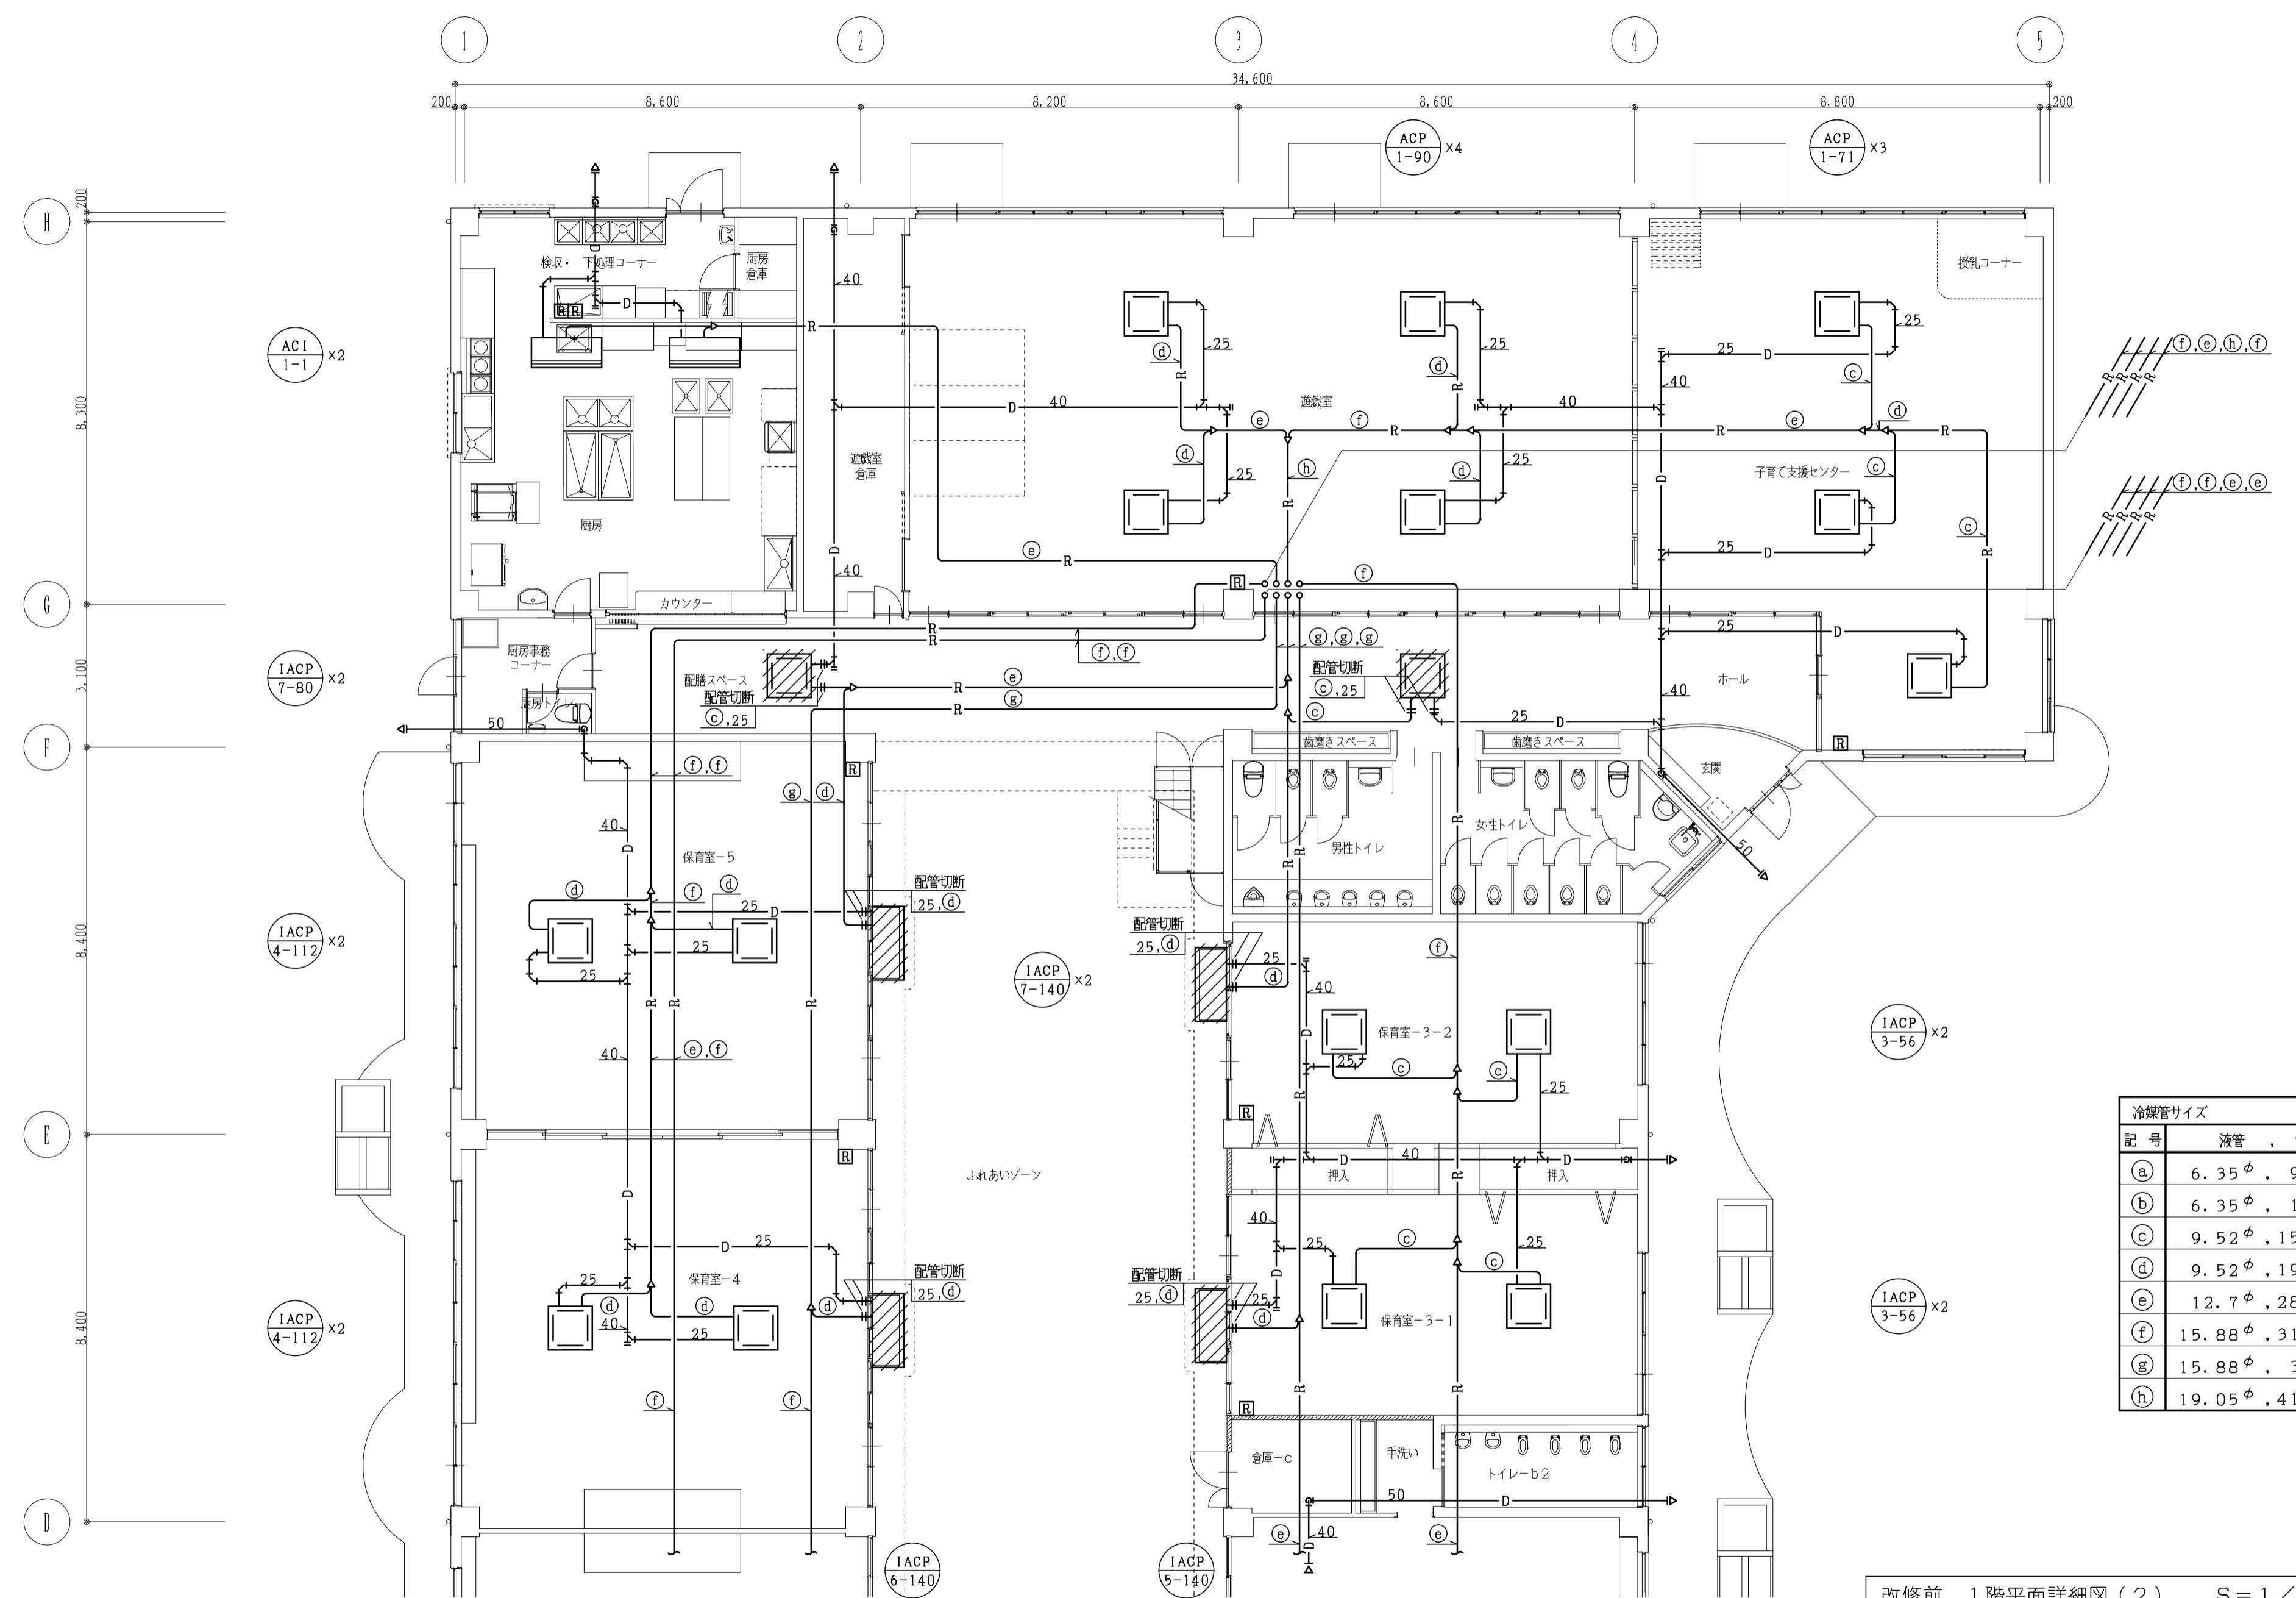


| | | | |
|-----|-----------------------|----|--|
| 工事名 | 本郷ひまわり保育所エアコン更新工事 | 縮尺 | |
| 図面名 | 空気調和設備 改修前 1階平面詳細図(2) | | |

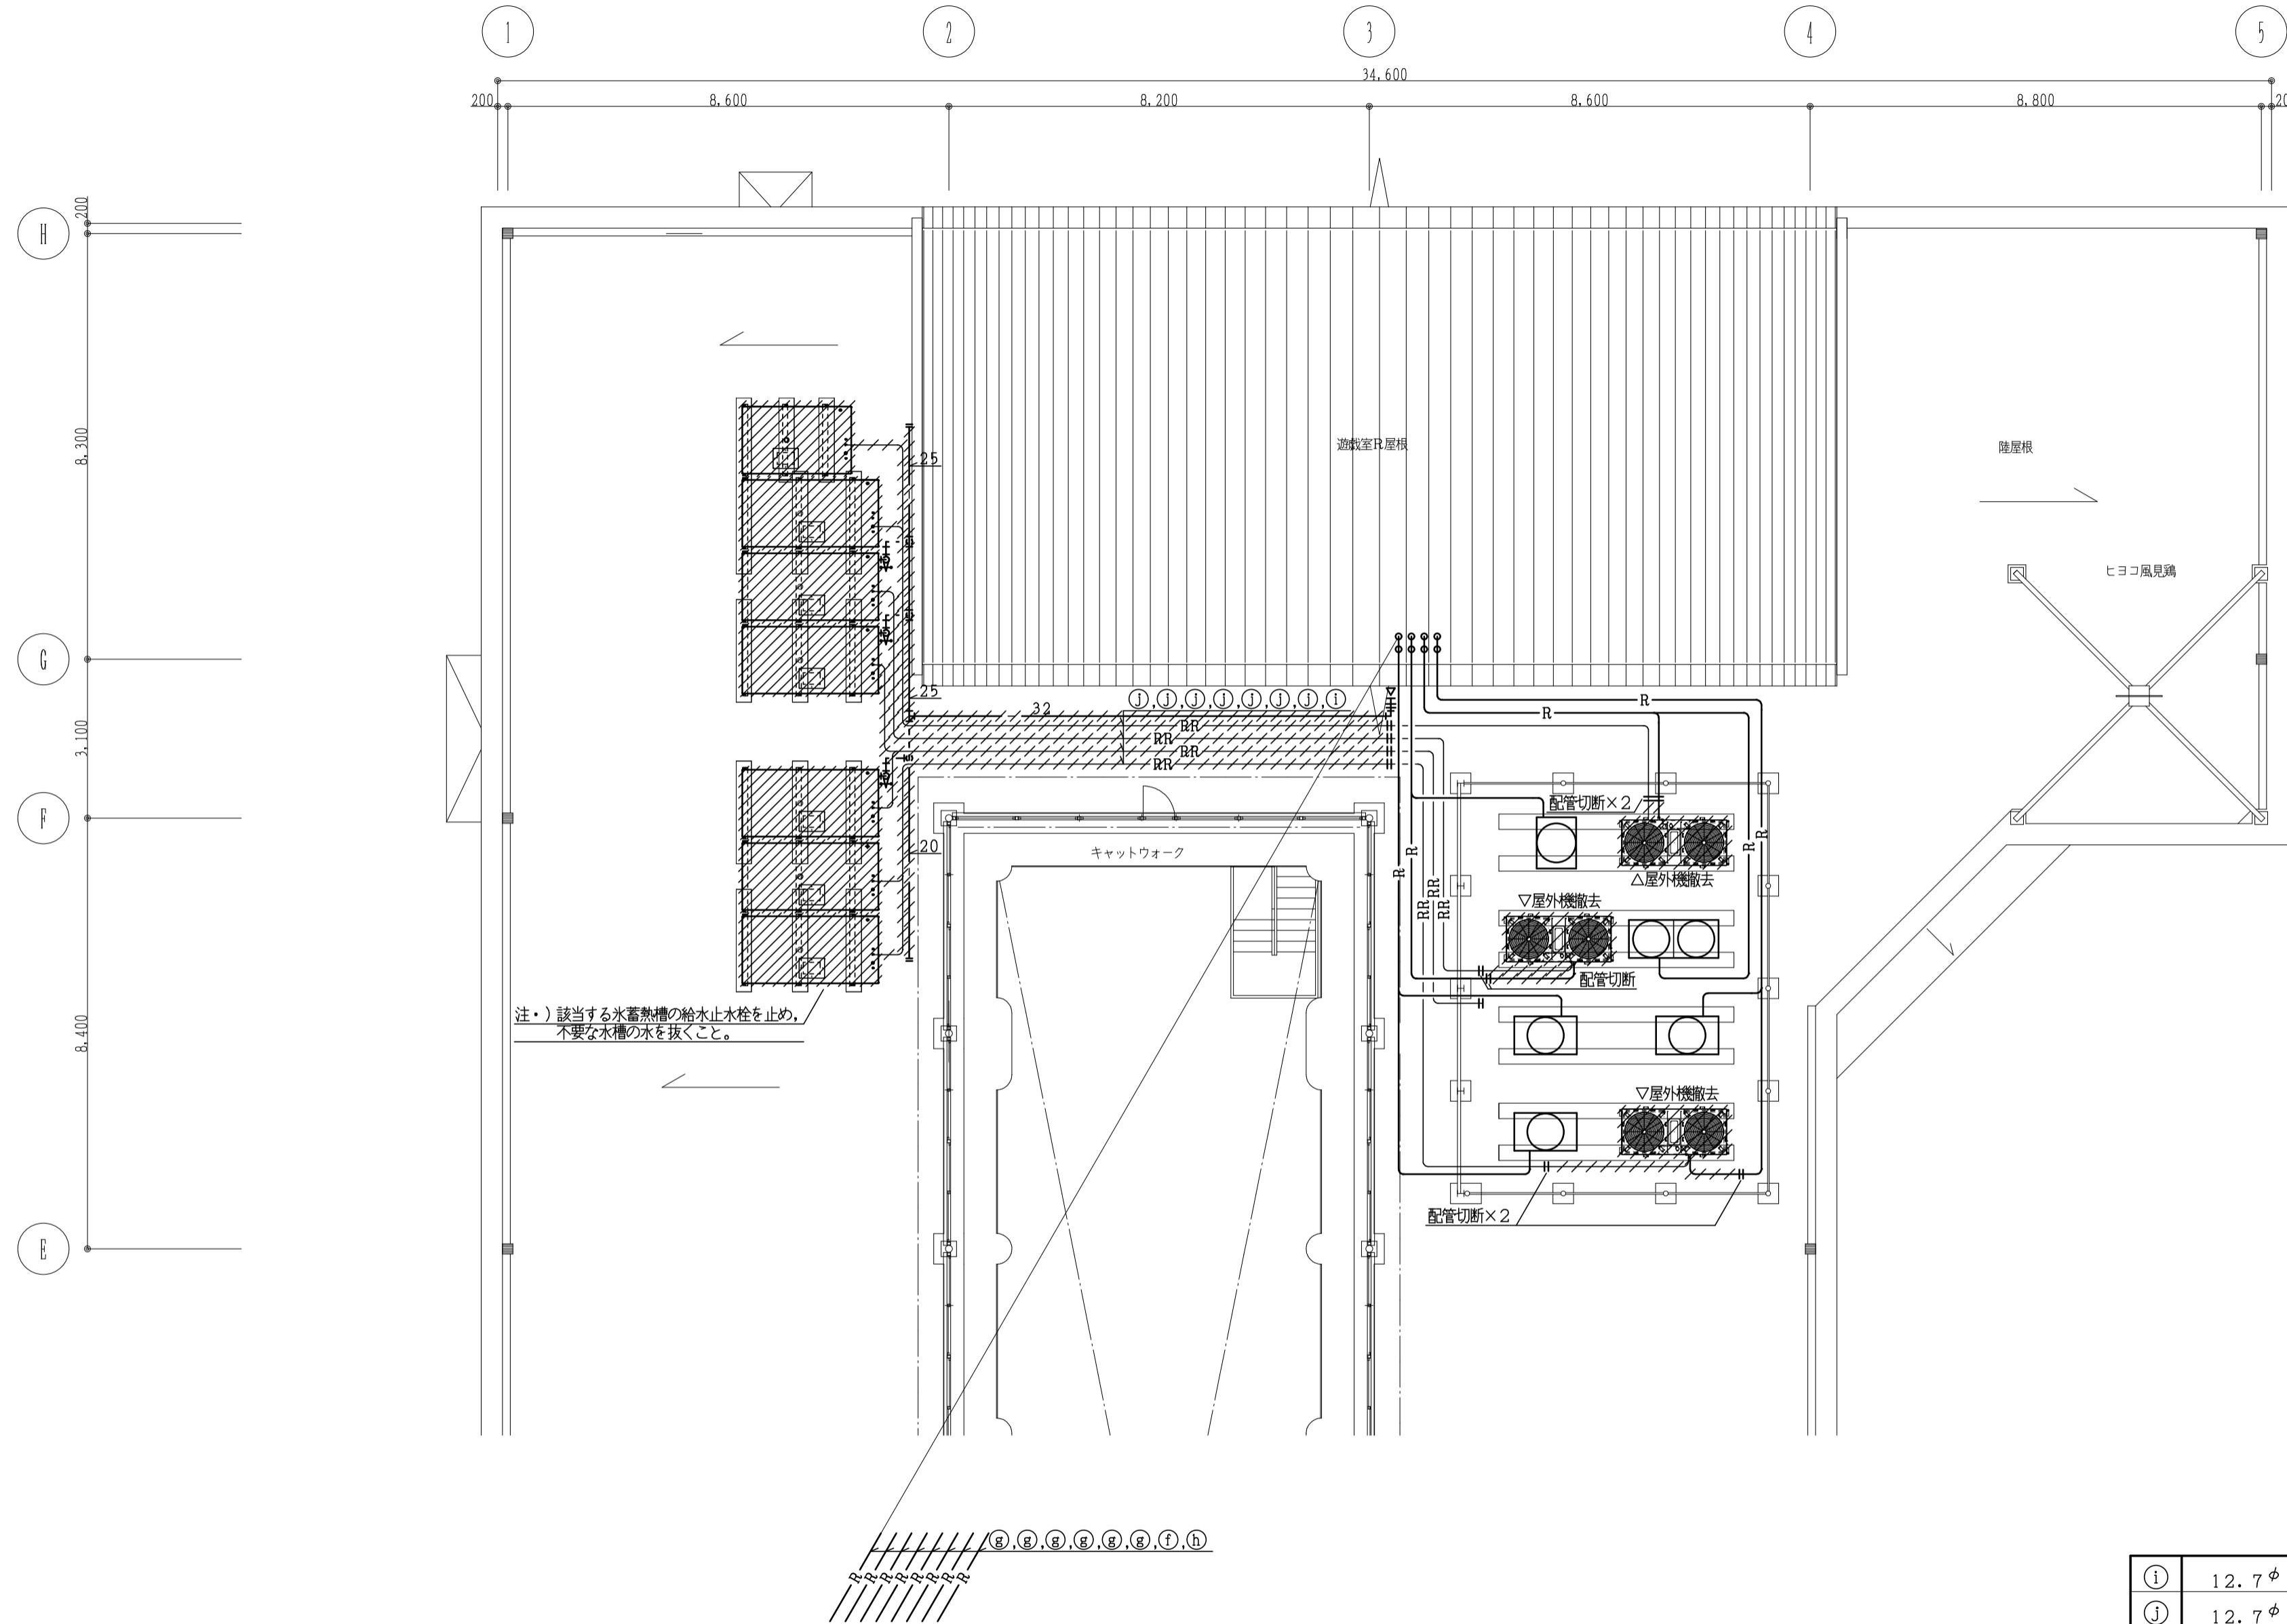


注・) 図示している屋上の冷媒配管については現地のラッキングで組合せで図示している。

改修前 屋上平面詳細図 S = 1 / 100

| 工事名 | 本郷ひまわり保育所エアコン更新工事 | 縮尺 | 図面番号 |
|-------|--------------------|----|------|
| 代表取締役 | 呼坂政明 | M | 12 |
| 図面名 | 空気調和設備 改修前 屋上平面詳細図 | | |

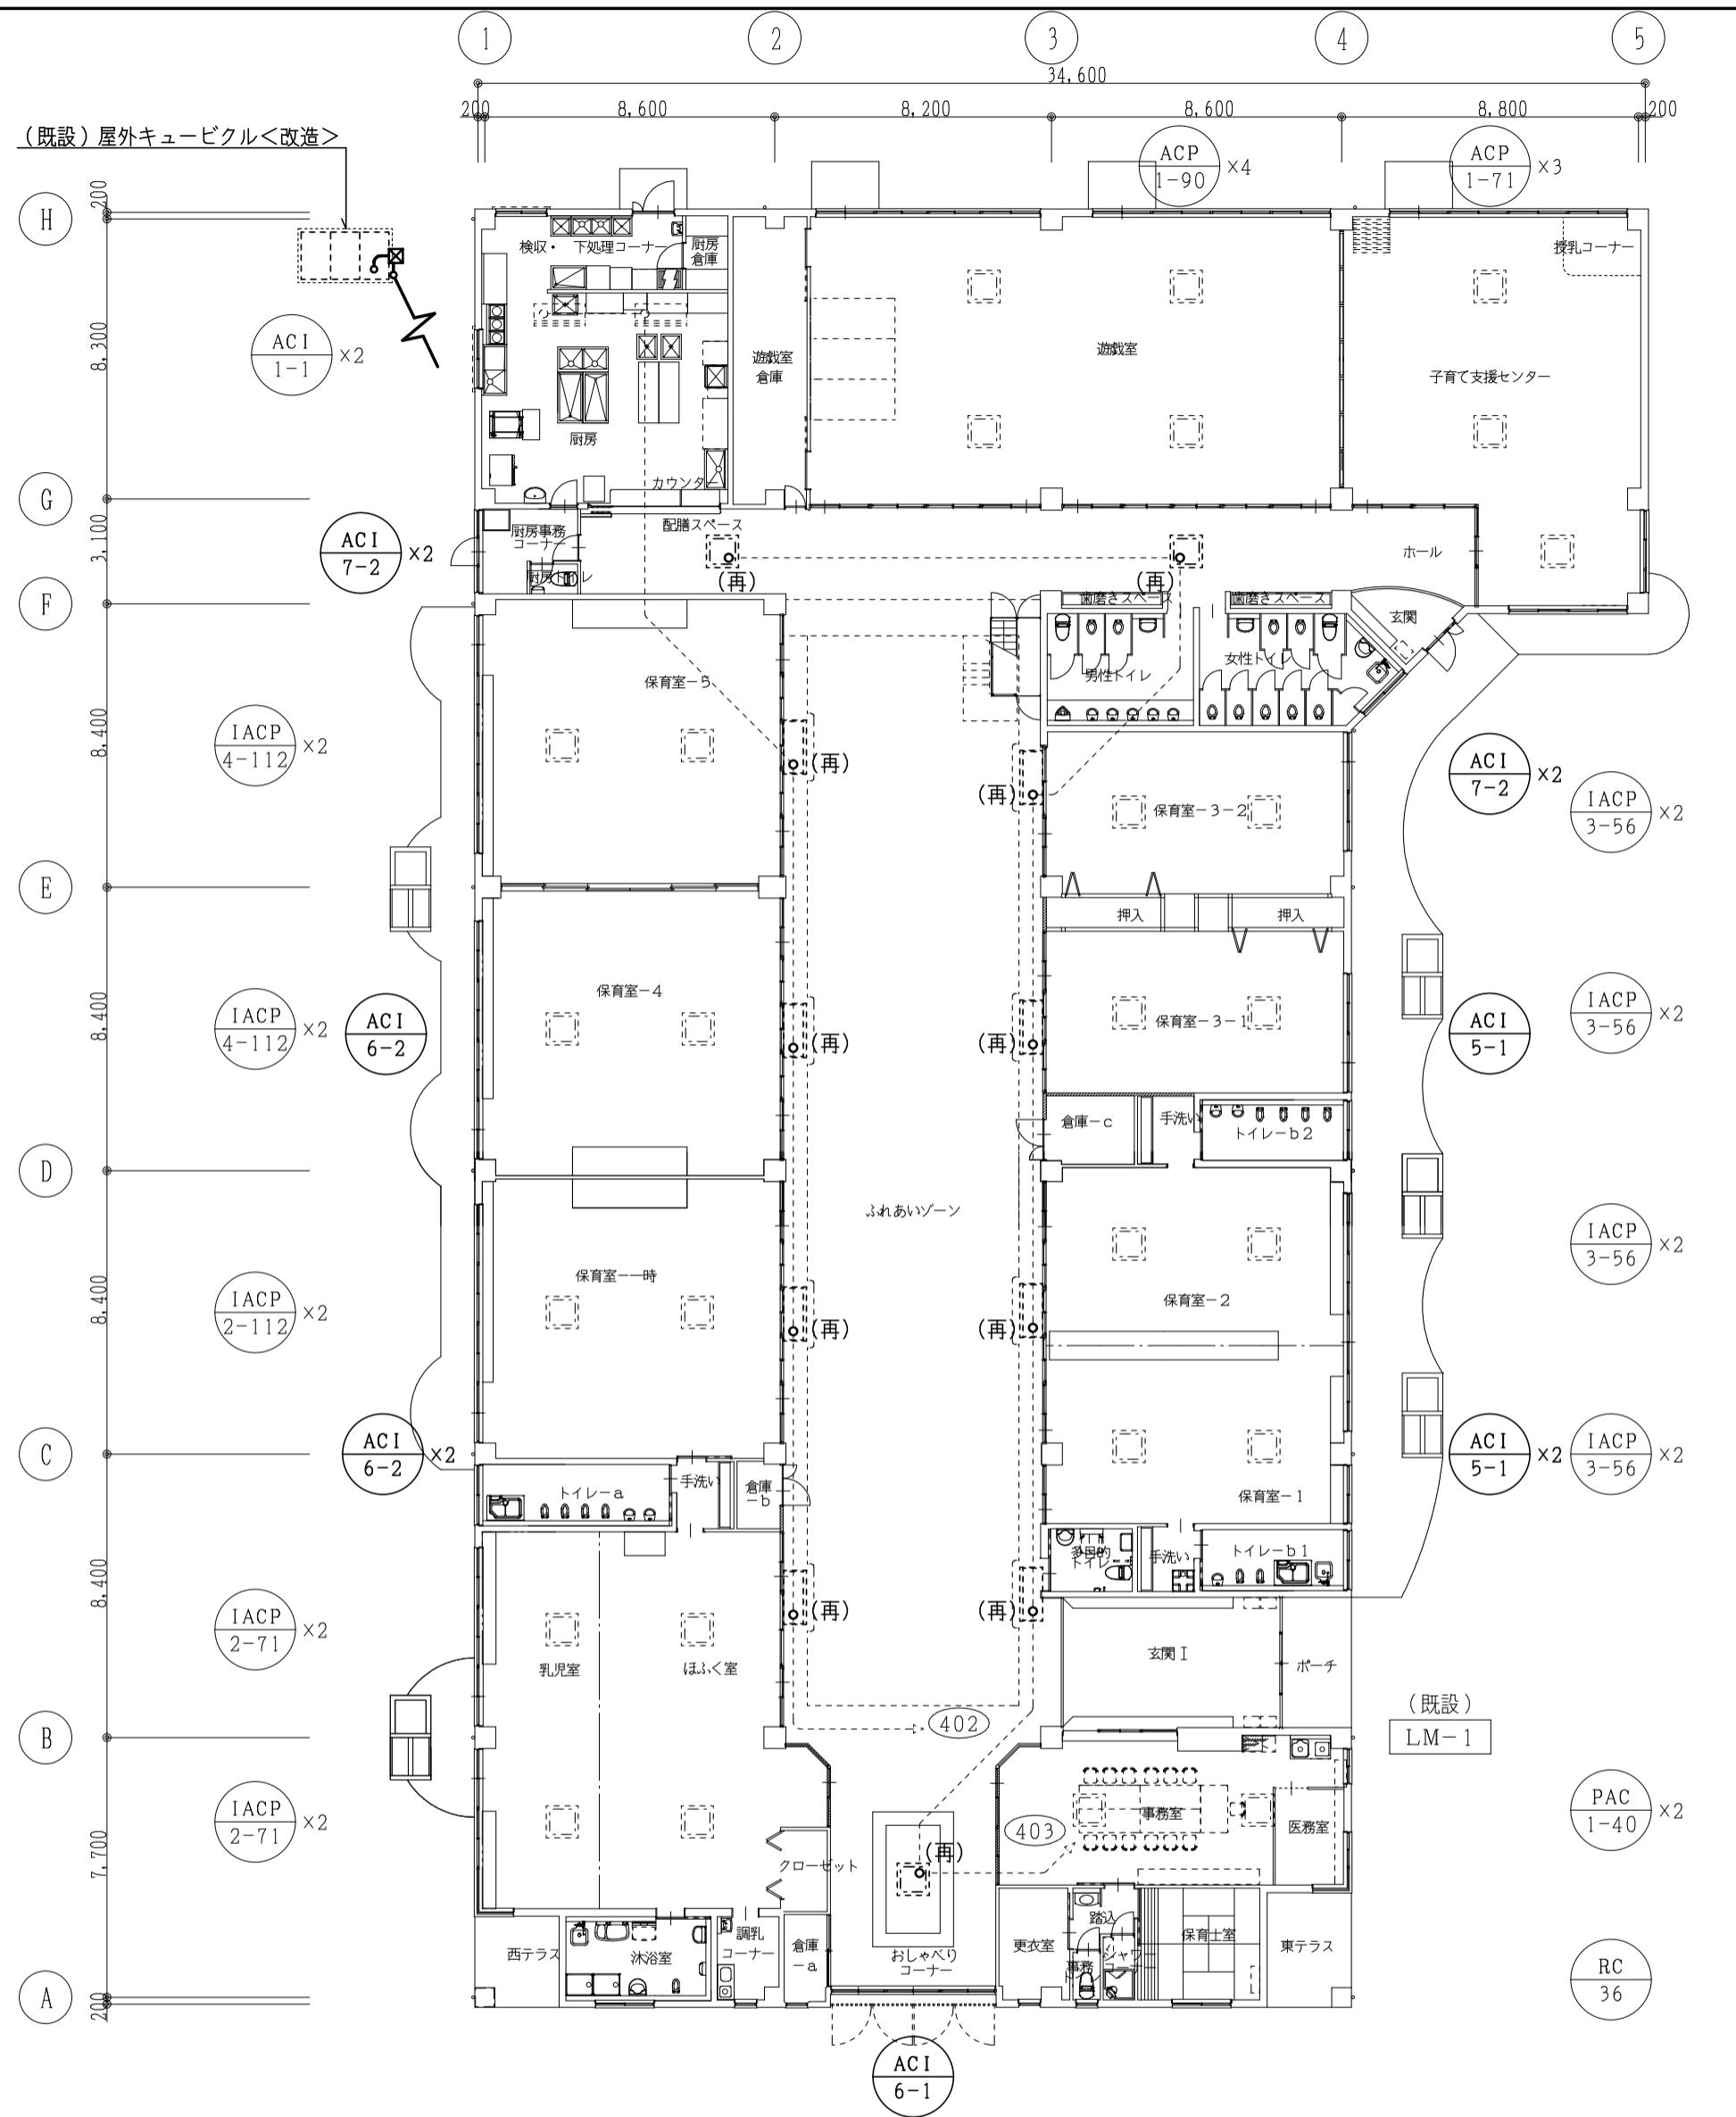


改修後 1階平面図 S=1/200

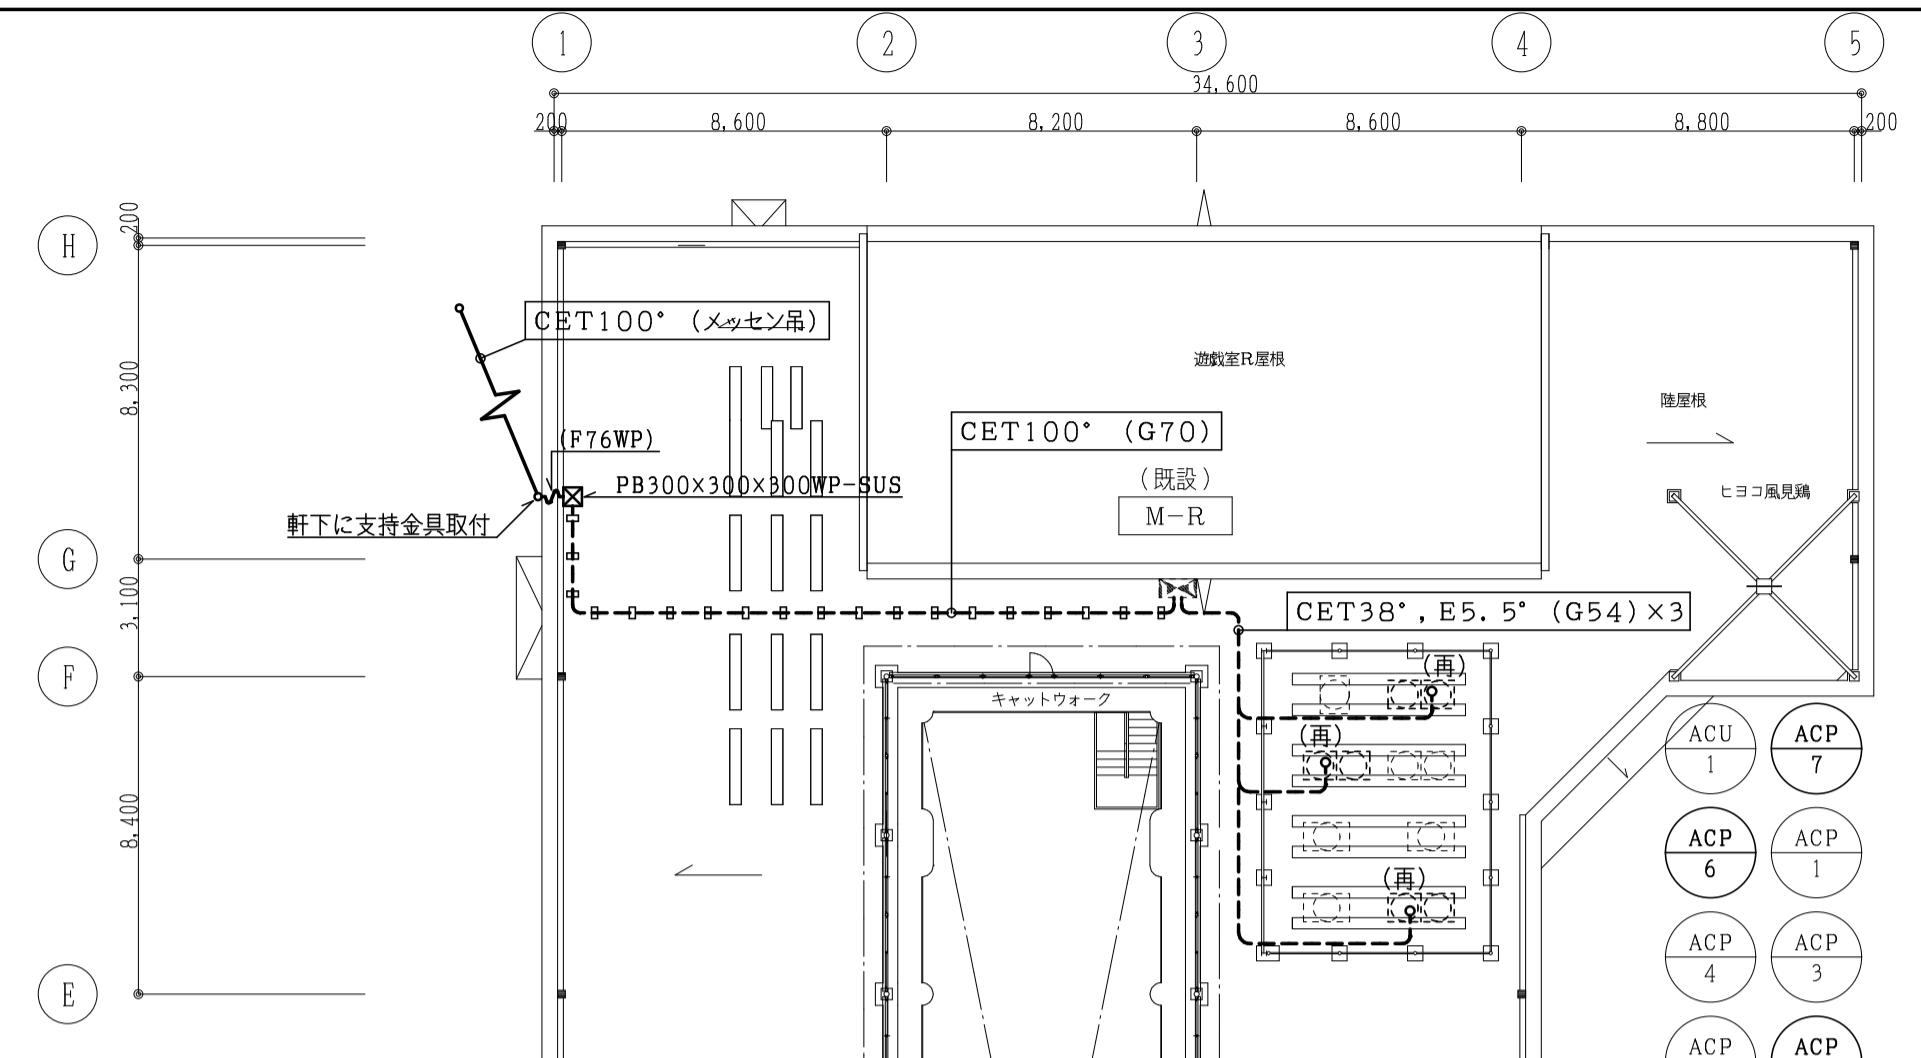

改修後 屋上平面図 S=1/200

-----は、既設を示す。

(再)印は、空調機結線取外し、再結線を示す。

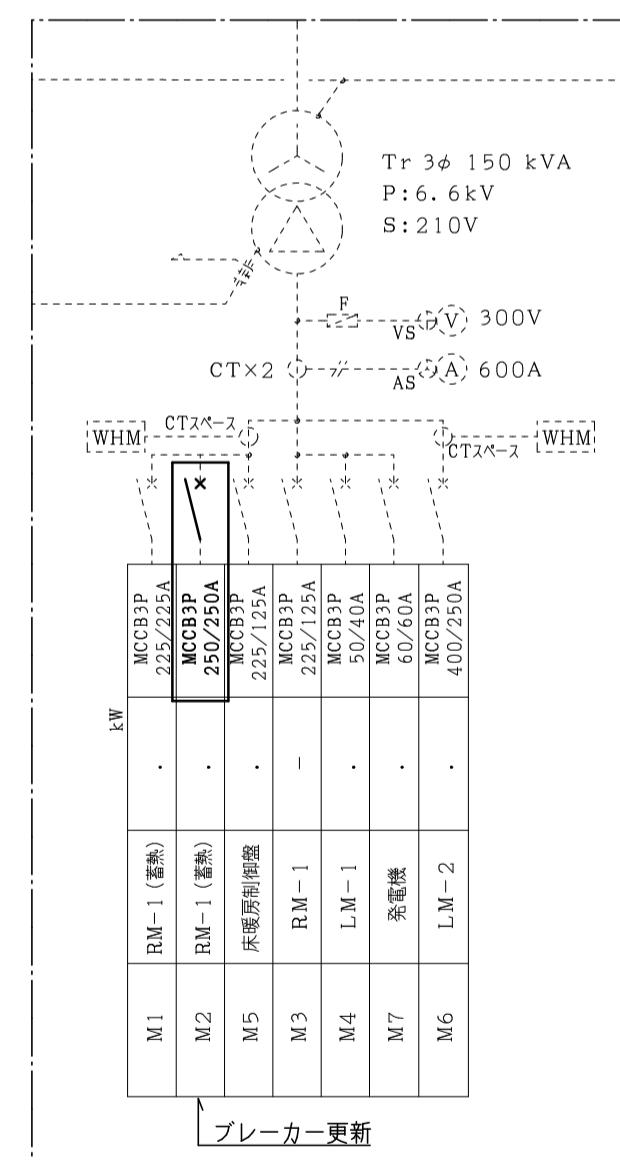


改修後 受変電設備図

株式会社 設 備 計 画
代表取締役 呼 坂 政 田

| | |
|-----|--------------------------|
| 工事名 | 本郷ひまわり保育所エアコン更新工事 |
| 図面名 | 空調電源 改修後 1階・屋上平面図、受変電設備図 |

縮尺
 $S=1$


図面番号
M 13

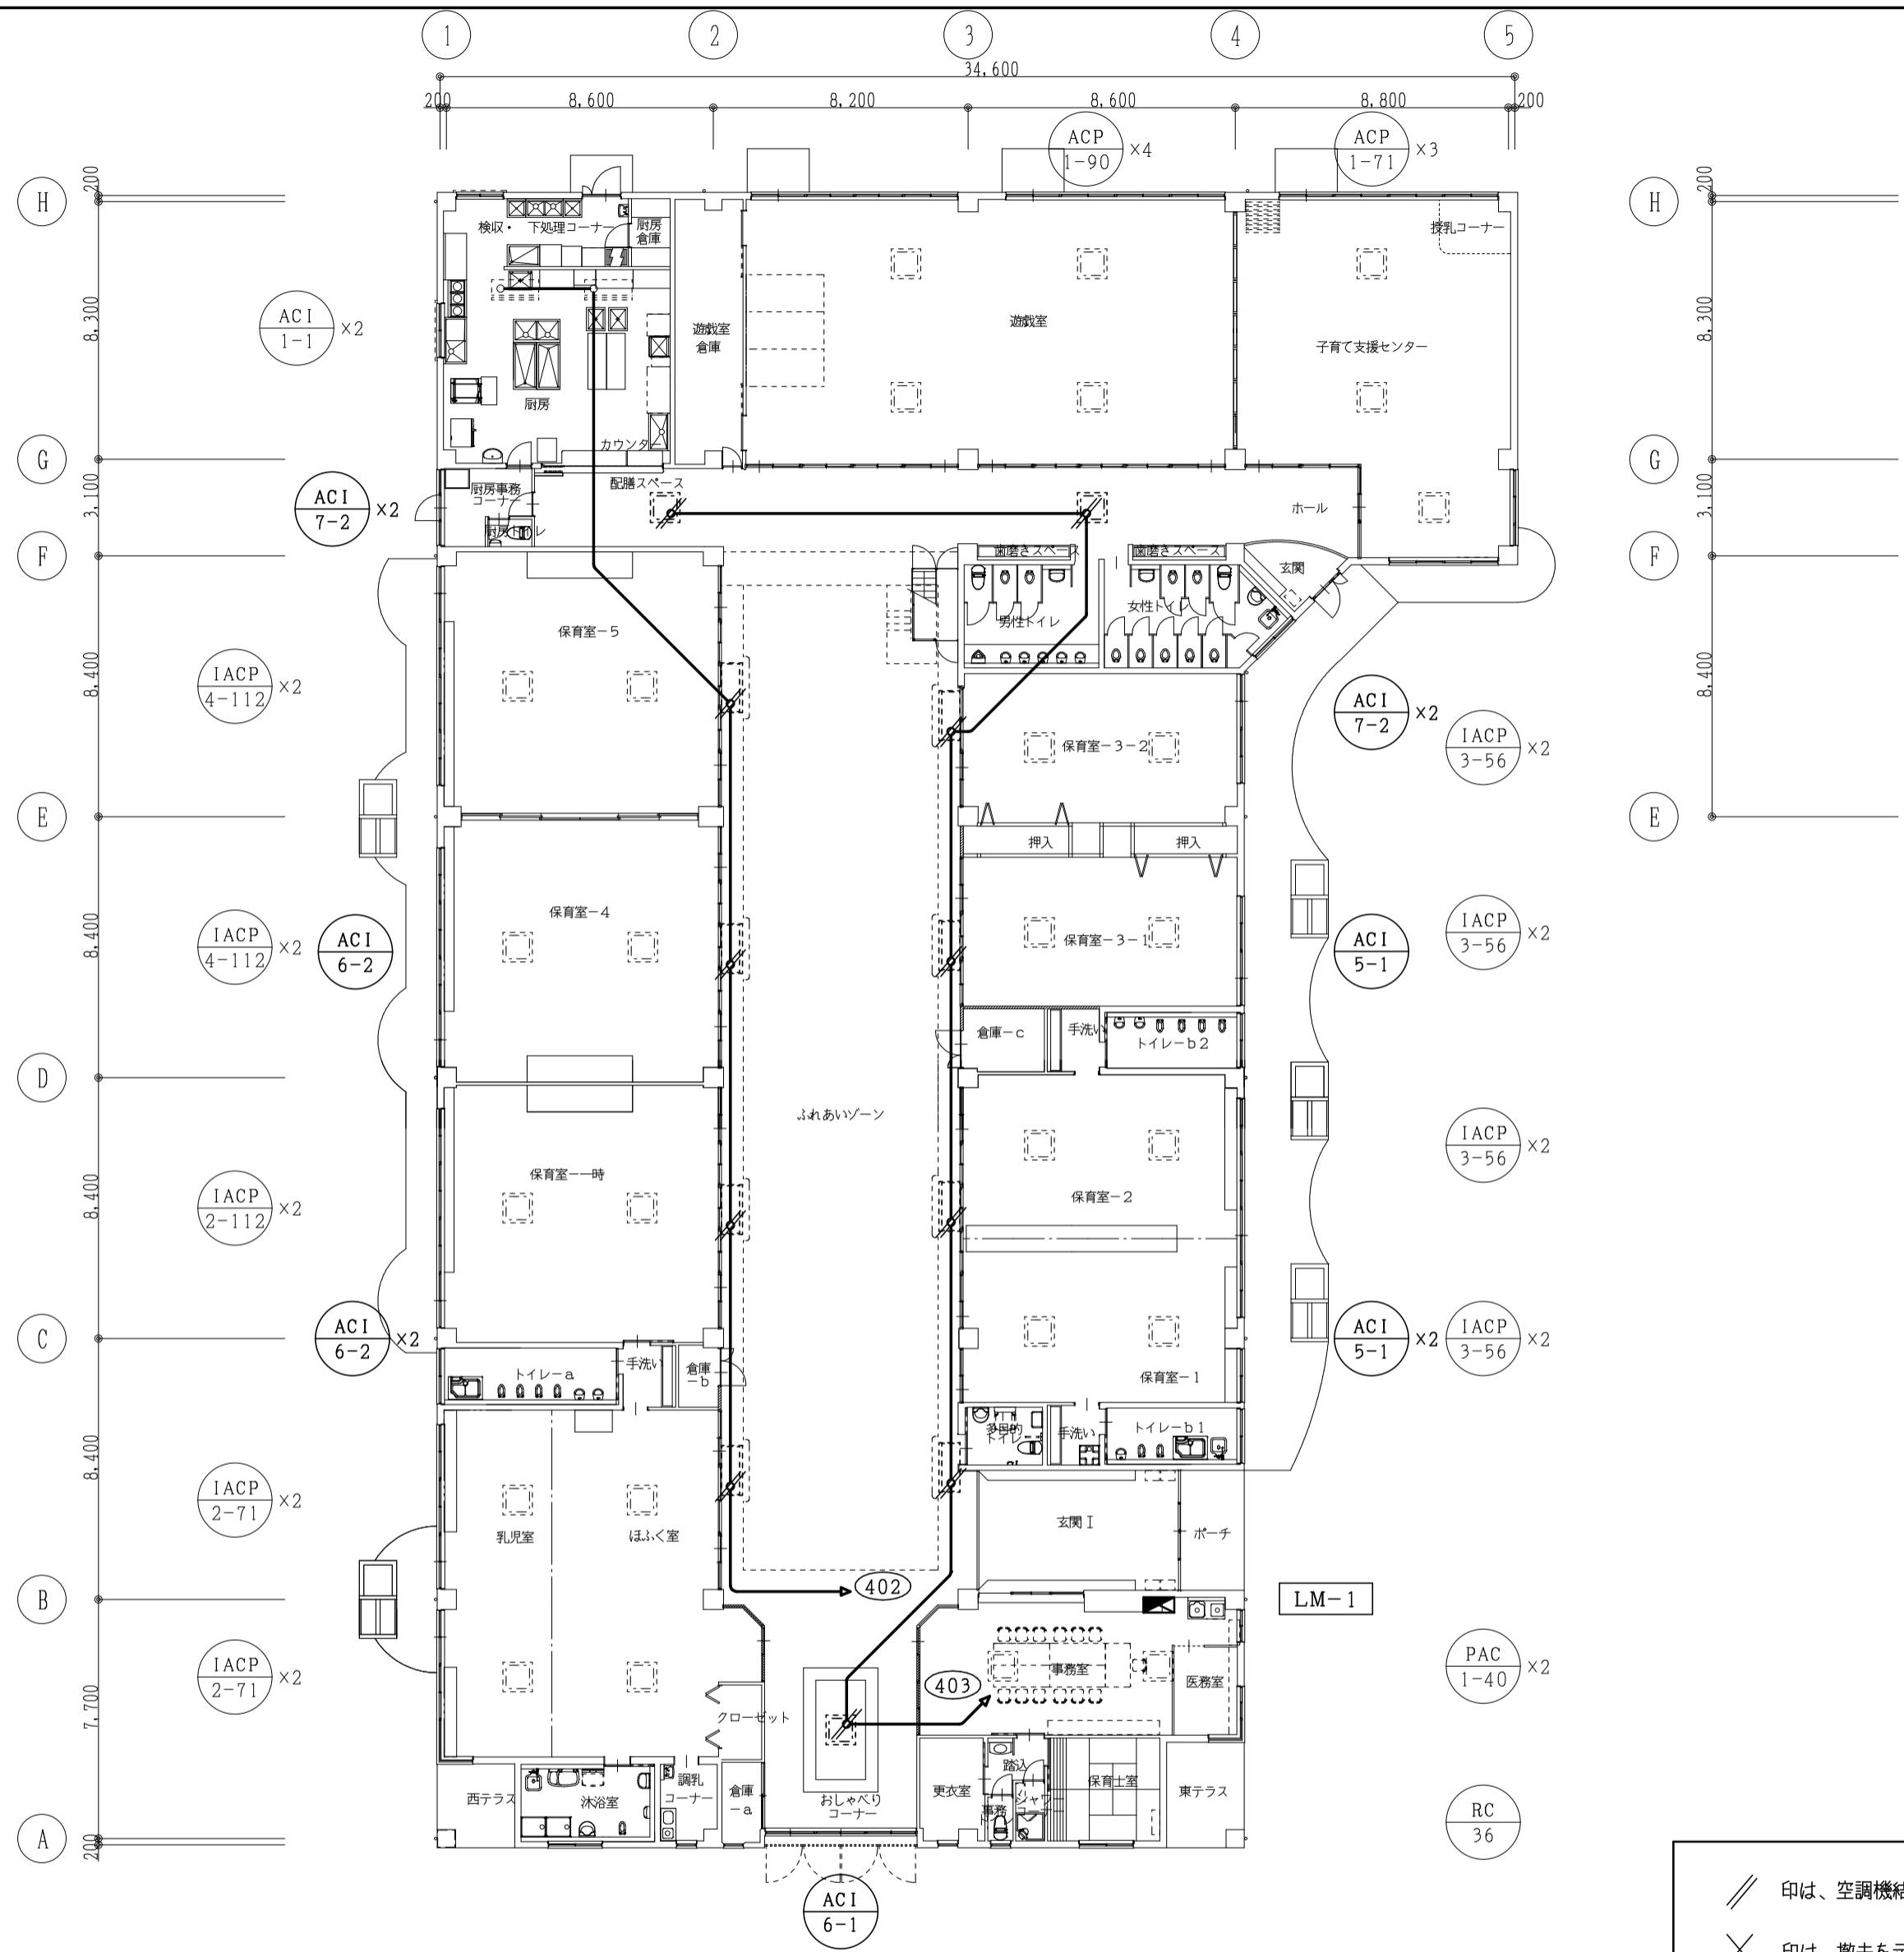


改修前 1階平面図 S=1/200

// 印は、空調機結線取外しを示す。


× 印は、撤去を示す。

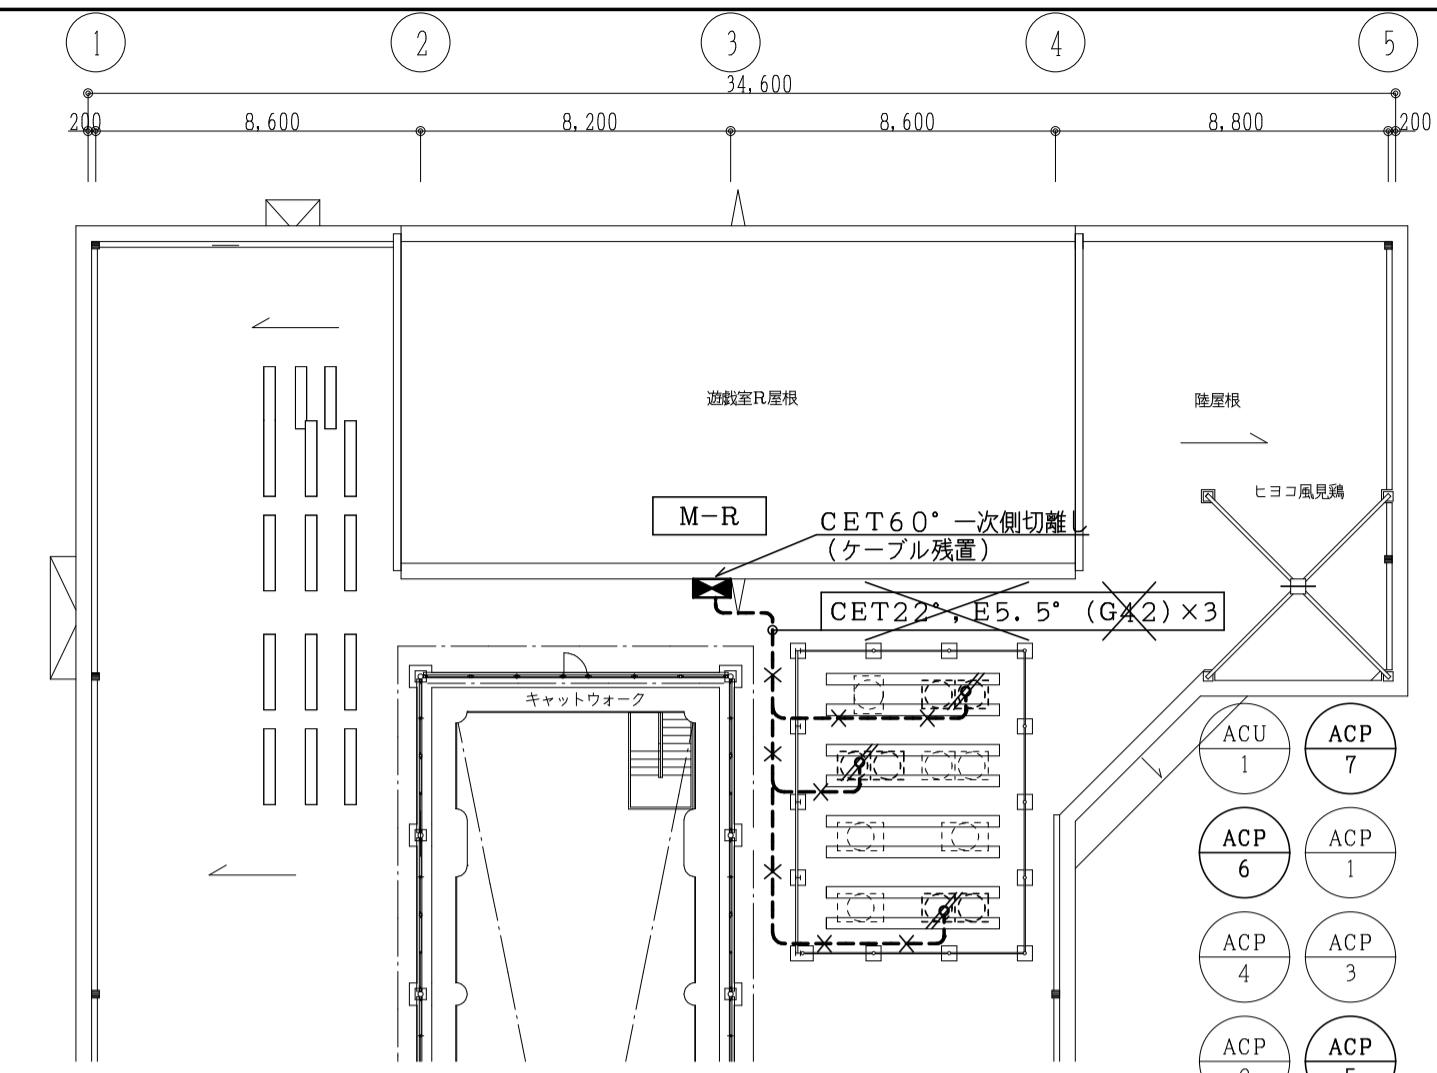

改修前 屋上平面図 S = 1 / 200

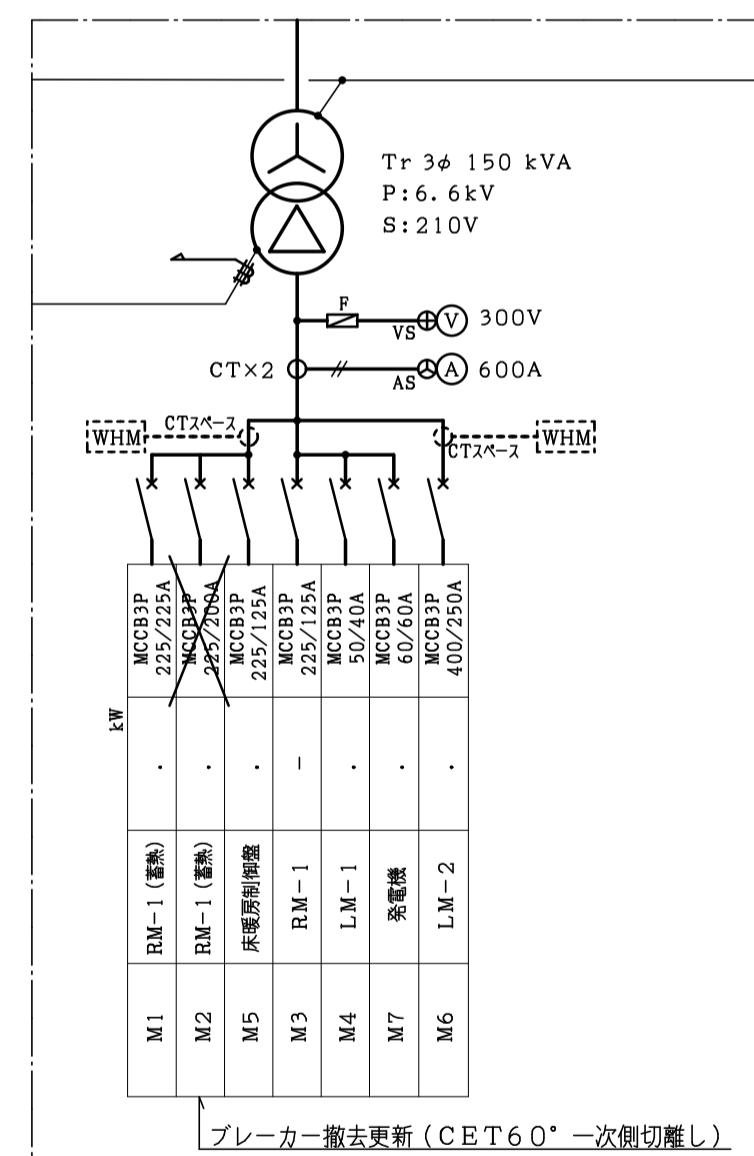

改修前 受変電設備図

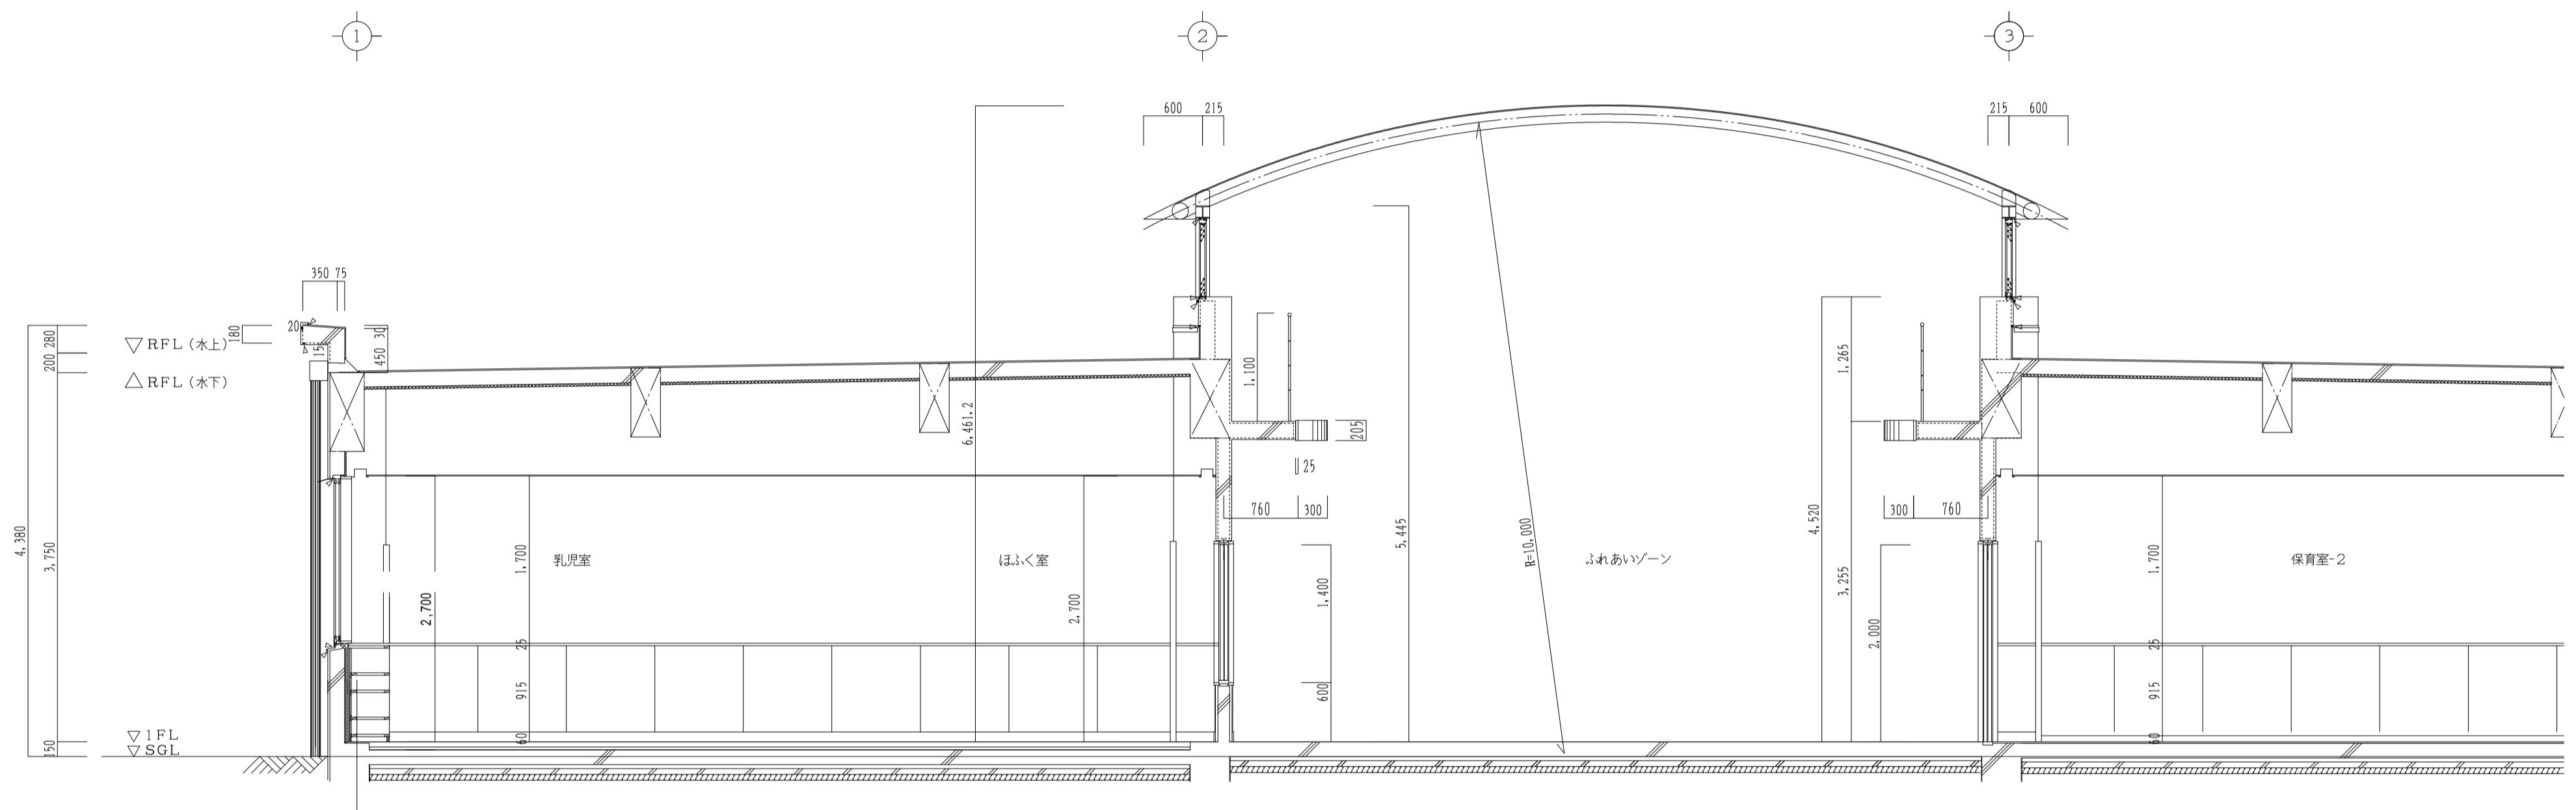

(参考) 1階断面図 S=1/50

| | | | | | |
|--|--|----------------------------|--------------------------|--------------|----------------|
| | | | 工事名 本郷ひまわり保育所エアコン更新工事 | 縮尺 S=1/50 | 図面番号 M / 15 |
| | | 株式会社 設 備 計 画 代表取締役 呼坂政明 | 図面名 (参考) 1階断面図 | | |

参考数量書

工事名称 本郷ひまわり保育所エアコン更新工事

[工事概要]

三原市下北方一丁目

| | |
|----------|--------------------------------|
| 用途、構造、面積 | 屋外機 3台 屋内機 11台 |
| 工事範囲 | 一式 |
| 別途発注工事 | なし |
| 工定期 | 契約締結日の翌日から 令和 8年3月19日までを工期とする。 |
| 一般事項 | |

《工事予算内訳》 設計金額 ¥ (税込み)

〈内訳〉

| 区分 | 金額 | 摘要 |
|------|----|----|
| 工事価格 | | |
| 消費税額 | | |
| | | |
| 設計金額 | | |

工事費内訳

| 名 称 | 数 量 | 单 位 | 金 额 | 備 考 |
|---------|-----|-----|-----|-----------|
| 直接工事費 | | | | |
| 機械設備工事 | 1 | 式 | | |
| 電気設備工事 | 1 | 式 | | |
| 計 | | | | |
| 共通費 | | | | |
| 共通仮設費 | 1 | 式 | | |
| 現場管理費 | 1 | 式 | | |
| 一般管理費等 | 1 | 式 | | |
| 計 | | | | |
| 工事価格 | 1 | 式 | | |
| 消費税等相当額 | 1 | 式 | | 消費税率 10 % |
| 工事費 | 1 | 式 | | |
| | | | | |
| | | | | |

工事種別内訳

機械設備工事 種目別内訳

電氣設備工事 種目別内訳

機械設備工事 科目別内訳

機械設備工事

電氣設備工事 科目別内訳

電氣設備工事

機械設備工事 中科目別内訳

機械設備工事

電気設備工事 中科目別内訳

電氣設備工事

機械設備工事 細目別内訳

| 機械設備工事 | | 空気調和設備 | | 機器設備 | | |
|--------------------------|--|--------|-----|------|-----|-----|
| 名 称 | 摘 要 | 数 量 | 单 位 | 单 価 | 金 頓 | 備 考 |
| ACP-5 マルチエアコン(屋外機) | 空冷ヒートポンプ マルチエアコン インバータ制御・冷暖切替運転型 冷房能力:56.0kW 暖房能力:63.0kW 付属品:スピーリング 防振架台, 外機渡り 分岐管 | 1 | 台 | | | |
| ACI-5-1 マルチエアコン (屋内機) | 空冷ヒートポンプ マルチエアコン 天吊露出形 冷房能力:14.0kW 暖房能力:16.0kW 付属品:昇降パネル, 昇降リモコン | 3 | 台 | | | |
| ACP-6 マルチエアコン(屋外機) | 空冷ヒートポンプ マルチエアコン インバータ制御・冷暖切替運転型 冷房能力:56.0kW 暖房能力:63.0kW 付属品:スピーリング 防振架台, 外機渡り 分岐管 | 1 | 台 | | | |
| ACI-6-1 マルチエアコン (屋内機) | 空冷ヒートポンプ マルチエアコン 天井埋込カセット形(4方向吹出) 冷房能力:5.6kW 暖房能力:6.3kW 付属品:昇降パネル, 昇降リモコン | 1 | 台 | | | |
| ACI-6-2 マルチエアコン (屋内機) | 空冷ヒートポンプ マルチエアコン 天吊露出形 冷房能力:14.0kW 暖房能力:16.0kW 付属品:昇降パネル, 昇降リモコン | 3 | 台 | | | |
| ACP-7 マルチエアコン(屋外機) | 空冷ヒートポンプ マルチエアコン インバータ制御・冷暖切替運転型 冷房能力:56.0kW 暖房能力:63.0kW 付属品:スピーリング 防振架台, 外機渡り 分岐管 | 1 | 台 | | | |
| ACI-7-1 マルチエアコン (屋内機) | 空冷ヒートポンプ マルチエアコン 天井埋込カセット形(4方向吹出) 冷房能力:8.0kW 暖房能力:9.0kW 付属品:昇降パネル, 昇降リモコン | 2 | 台 | | | |
| ACI-7-2 マルチエアコン (屋内機) | 空冷ヒートポンプ マルチエアコン 天吊露出形 冷房能力:14.0kW 暖房能力:16.0kW | | | | | |

機械設備工事 細目別内訳

機械設備工事 細目別内訳

| 機械設備工事 | | 空気調和設備 | | 配管設備 | | |
|---------------------------|--------------------------------|--------|----------------|------|-----|------------|
| 名 称 | 摘 要 | 数 量 | 单 位 | 单 価 | 金 領 | 備 考 |
| 冷媒用 断熱材被覆銅管 | 9.52外径(3/8B) 液管 厚10mm以上 | 16 | m | | | |
| 冷媒用 断熱材被覆銅管 | 15.88外径(5/8B) 液管 厚10mm以上 | 3 | m | | | |
| 冷媒用 断熱材被覆銅管 | 15.88外径(5/8B) 加入管 厚20mm以上 | 5 | m | | | |
| 冷媒用 断熱材被覆銅管 | 19.05外径(3/4B) 加入管 厚20mm以上 | 11 | m | | | |
| 冷媒用 断熱材被覆銅管 | 31.75外径(1 1/4B) 加入管 厚20mm以上 | 1 | m | | | |
| 冷媒用 断熱材被覆銅管 | 38.1 外径(1 1/2B) 加入管 厚20mm以上 | 3 | m | | | |
| 排水・硬質ポリ 塩化ビニル管 (VP) | 屋内一般 25A | 6 | m | | | |
| 保温 | | 1 | 式 | | | 別紙 00-0019 |
| 養生(内部改修) | 塗装塗替え程度 | 44 | m ² | | | |
| 整理清掃後片付け (内部改修) | 塗装塗替え程度 | 44 | m ² | | | |
| 天井点検口新設 | | 7 | か所 | | | |
| 計 | | | | | | |
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機械設備工事 細目別内訳

機械設備工事 細目別内訳

機械設備工事 細目別内訳

機械設備工事 細目別内訳

電氣設備工事 細目別内訳

電氣設備工事 細目別内訳

電氣設備工事 細目別内訳

機械設備工事 別紙明細

| 機械設備工事 | | 空気調和設備 | | 機器設備 | | |
|---------------------------|------------------------------|--------|-----|------|-----|------------|
| 名 称 | 摘 要 | 数 量 | 单 位 | 单 価 | 金 領 | 備 考 |
| 搬入・据付費 | | 1 | 式 | | | 別紙 00-0006 |
| パッケージ形空気調和機(セパレート・マルチ) 据付 | 屋外機 床置き 防振基礎有り 56.0kW以下 | 3 | 台 | | | |
| パッケージ形空気調和機(セパレート・マルチ) 据付 | 屋内機 天井吊り - 14.0kW以下 | 8 | 台 | | | |
| パッケージ形空気調和機(セパレート・マルチ) 据付 | 屋内機 天井吊り - 5.6kW以下 | 1 | 台 | | | |
| パッケージ形空気調和機(セパレート・マルチ) 据付 | 屋内機 天井吊り - 8.0kW以下 | 2 | 台 | | | |
| ワイヤードリモコン据付 | | 3 | 個 | | | |
| ON/OFFリモコン据付 | | 1 | 個 | | | |
| 搬入費 | 複数搬入 200kg/m ³ 未満 | 0.3 | t | | | |
| 搬入費 | 複数搬入 200kg/m ³ 未満 | 0.3 | t | | | |
| 搬入費 | 複数搬入 200kg/m ³ 未満 | 0.3 | t | | | |
| 計 | | | | | | |
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機械設備工事 別紙明細

機械設備工事 別紙明細

機械設備工事 別紙明細

| 機械設備工事 | | 撤去工事 | | 空気調和設備 | | |
|----------------------------------|---|------|-----|--------|-----|------------|
| 名 称 | 摘 要 | 数 量 | 单 位 | 单 価 | 金 領 | 備 考 |
| 撤去費 | | 1 | 式 | | | 別紙 00-0047 |
| IACP-5 マルチエアコン(屋外機) 撤去 | 空冷ヒートポンプ マルチエアコン 冷房能力:45.0kW 暖房能力:33.5kW | 1 | 台 | | | |
| IACP-5-140 マルチエアコン(屋内機) 撤去 | 空冷ヒートポンプ マルチエアコン 天吊露出形 冷房能力:14.0kW 暖房能力:16.0kW | 3 | 台 | | | |
| IACP-6 マルチエアコン(屋外機) 撤去 | 空冷ヒートポンプ マルチエアコン 冷房能力:45.0kW 暖房能力:33.5kW | 1 | 台 | | | |
| IACP-6-56 マルチエアコン(屋内機) 撤去 | 空冷ヒートポンプ マルチエアコン 天井埋込カセット形(4方向吹出) 冷房能力:5.6kW 暖房能力:6.3kW | 1 | 台 | | | |
| IACP-6-140 マルチエアコン(屋内機) 撤去 | 空冷ヒートポンプ マルチエアコン 天吊露出形 冷房能力:14.0kW 暖房能力:16.0kW | 3 | 台 | | | |
| IACP-7 マルチエアコン(屋外機) 撤去 | 空冷ヒートポンプ マルチエアコン 冷房能力:45.0kW 暖房能力:33.5kW | 1 | 台 | | | |
| ACI-7-1 マルチエアコン(屋内機) 撤去 | 空冷ヒートポンプ マルチエアコン 天井埋込カセット形(4方向吹出) 冷房能力:8.0kW 暖房能力:9.0kW | 2 | 台 | | | |
| ACI-7-2 マルチエアコン(屋内機) 撤去 | 空冷ヒートポンプ マルチエアコン 天吊露出形 冷房能力:14.0kW 暖房能力:16.0kW | 2 | 台 | | | |
| ワイヤードリモコン撤去 | | 3 | 個 | | | |
| ON/OFFリモコン撤去 | | 1 | 個 | | | |
| 氷蓄熱ユニット撤去 | (外形寸法)W1260×D2000×H2240 (重量)600kg | 6 | 台 | | | |
| 氷蓄熱ユニット撤去 | (外形寸法)W900×D1080×H2100 (重量)210kg | 1 | 台 | | | |
| 冷媒回収費 | IACP-5 R407 17.0kg | 1 | 式 | | | |
| 冷媒回収費 | IACP-6 R407 17.0kg | 1 | 式 | | | |

機械設備工事 別紙明細

機械設備工事 別紙明細

| 機械設備工事 | | 撤去工事 | | 空氣調和設備 | | |
|----------|------------------------------|------|-----|--------|-----|------------|
| 名 称 | 摘 要 | 数 量 | 单 位 | 单 価 | 金 領 | 備 考 |
| 搬出費 | | 1 | 式 | | | 別紙 00-0048 |
| 搬出費(撤去用) | 複数搬出 200kg/m ³ 未満 | 0.5 | t | | | |
| 搬出費(撤去用) | 複数搬出 200kg/m ³ 未満 | 0.5 | t | | | |
| 搬出費(撤去用) | 複数搬出 200kg/m ³ 未満 | 0.5 | t | | | |
| 搬出費(撤去用) | 複数搬出 200kg/m ³ 未満 | 0.6 | t | | | |
| 搬出費(撤去用) | 複数搬出 200kg/m ³ 未満 | 0.6 | t | | | |
| 搬出費(撤去用) | 複数搬出 200kg/m ³ 未満 | 0.6 | t | | | |
| 搬出費(撤去用) | 複数搬出 200kg/m ³ 未満 | 0.6 | t | | | |
| 搬出費(撤去用) | 複数搬出 200kg/m ³ 未満 | 0.6 | t | | | |
| 搬出費(撤去用) | 複数搬出 200kg/m ³ 未満 | 0.6 | t | | | |
| 計 | | | | | | |
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機械設備工事 別紙明細

| 機械設備工事 | | 撤去工事 | | 空氣調和設備 | | |
|--------------------|-----------|------|-----|--------|-----|------------|
| 名 称 | 摘 要 | 数 量 | 单 位 | 单 価 | 金 頓 | 備 考 |
| 配管類撤去 | | 1 | 式 | | | 別紙 00-0049 |
| 断熱材被覆銅管 撤去 | 液管 9.52 | 8 | m | | | |
| 断熱材被覆銅管 撤去 | 液管 12.7 | 105 | m | | | |
| 断熱材被覆銅管 撤去 | 液管 15.88 | 4 | m | | | |
| 断熱材被覆銅管 撤去 | ガス管 12.7 | 16 | m | | | |
| 断熱材被覆銅管 撤去 | ガス管 15.88 | 82 | m | | | |
| 断熱材被覆銅管 撤去 | ガス管 19.05 | 6 | m | | | |
| 断熱材被覆銅管 撤去 | ガス管 22.2 | 96 | m | | | |
| 断熱材被覆銅管 撤去 | ガス管 28.58 | 8 | m | | | |
| 断熱材被覆銅管 撤去 | ガス管 31.75 | 1 | m | | | |
| 断熱材被覆銅管 撤去 | ガス管 38.1 | 100 | m | | | |
| 硬質塩化ビニル管 (VP)撤去 | 屋内一般 25A | 6 | m | | | |
| 計 | | | | | | |
| | | | | | | |
| | | | | | | |

機械設備工事 別紙明細

| 機械設備工事 | | 撤去工事 | | 空気調和設備 | | |
|----------------------------|---|------|-----|--------|-----|------------|
| 名 称 | 摘 要 | 数 量 | 单 位 | 单 価 | 金 領 | 備 考 |
| 保温類撤去 | | 1 | 式 | | | 別紙 00-0050 |
| 冷媒用 断熱材被覆銅管用 保温外装 撤去 | | 100 | m | | | |
| 排水管 保温撤去 | ガラスウール 屋内露出 合成樹脂製ガス-1及び2 25A 再使用しない | 6 | m | | | |
| 計 | | | | | | |
| | | | | | | |
| 配管切断 | | 1 | 式 | | | 別紙 00-0051 |
| 断熱材被覆銅管 切断 | 液管9.52 /ガス管15.88 | 4 | か所 | | | |
| 断熱材被覆銅管 切断 | 液管9.52 /ガス管19.05 | 6 | か所 | | | |
| 断熱材被覆銅管 切断 | 液管15.88 /ガス管31.75 | 1 | か所 | | | |
| 断熱材被覆銅管 切断 | 液管15.88 /ガス管38.1 | 3 | か所 | | | |
| 断熱材被覆銅管 切断 | 液管12.7 /ガス管12.7 ガス管22.22 ,38.1 | 1 | か所 | | | |
| 断熱材被覆銅管 切断 | 液管12.7 /ガス管15.88 ガス管22.22 ,38.1 | 10 | か所 | | | |
| 配管切断 (樹脂管類) ・手間のみ | 配管切断 25A 保温有 | 11 | か所 | | | |
| 計 | | | | | | |
| | | | | | | |

機械設備工事 別紙明細

| 機械設備工事 | | 撤去工事 | | 給水設備 | | |
|----------------------------------|---|------|-----|------|-----|------------|
| 名 称 | 摘 要 | 数 量 | 单 位 | 单 価 | 金 頓 | 備 考 |
| 配管類撤去 | | 1 | 式 | | | 別紙 00-0052 |
| 水道用硬質塩ビ ライング 鋼管 (SGP-VB)撤去 | 屋内一般 20A | 5 | m | | | |
| 水道用硬質塩ビ ライング 鋼管 (SGP-VB)撤去 | 屋内一般 25A | 6 | m | | | |
| 水道用硬質塩ビ ライング 鋼管 (SGP-VB)撤去 | 屋内一般 32A | 9 | m | | | |
| 計 | | | | | | |
| | | | | | | |
| 保温類撤去 | | 1 | 式 | | | 別紙 00-0053 |
| 給水管 保温撤去 | ポリスチレン 屋外露出,浴室 ステンレス鋼板 20A 再使用しない | 5 | m | | | |
| 給水管 保温撤去 | ポリスチレン 屋外露出,浴室 ステンレス鋼板 25A 再使用しない | 6 | m | | | |
| 給水管 保温撤去 | ポリスチレン 屋外露出,浴室 ステンレス鋼板 32A 再使用しない | 9 | m | | | |
| 計 | | | | | | |
| | | | | | | |
| 配管切断 | | 1 | 式 | | | 別紙 00-0054 |
| 配管切断 (鋼管類) ・手間のみ | 配管切断 32A 保温有 | 1 | か所 | | | |
| 計 | | | | | | |

機械設備工事 別紙明細

| 機械設備工事 発生材処理 | | | | | | |
|--------------|--------|--------|-----|-----|-----|------------|
| 名 称 | 摘 要 | 数 量 | 单 位 | 单 価 | 金 領 | 備 考 |
| 発生材処分 | | 1 | 式 | | | 別紙 00-0055 |
| 鉄くず | H2 | 0.05 | t | | | |
| 鉄くず | H3 | 0.01 | t | | | |
| 鉄くず | 故鉄 | 5.7 | t | | | |
| ステンレス | | 4.56 | k g | | | |
| 銅 | 1号 | 274.05 | k g | | | |
| 廃プラ処分 | | 0.02 | t | | | |
| ガラス陶器くず処分 | 保温くず | 0.03 | t | | | |
| 冷媒処分費 | IACP-5 | 1 | 式 | | | |
| 冷媒処分費 | IACP-6 | 1 | 式 | | | |
| 冷媒処分費 | IACP-7 | 1 | 式 | | | |
| 計 | | | | | | |
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機械設備工事 別紙明細

電氣設備工事 別紙明細

電気設備工事 別紙明細

| 電気設備工事 | | 動力設備 | | | 動力幹線 | |
|----------------------------|-----------------|------|-----|-----|------|------------|
| 名 称 | 摘 要 | 数 量 | 单 位 | 单 価 | 金 領 | 備 考 |
| メッセージ・ワイヤー | | 1 | 式 | | | 別紙 00-0058 |
| メッセージ・ワイヤー | 22mm2 | 6 | m | | | |
| 計 | | | | | | |
| | | | | | | |
| ケーブル | | 1 | 式 | | | 別紙 00-0059 |
| EM-CETケーブル | 100mm2 管内 | 21 | m | | | |
| EM-CETケーブル | 100mm2 ピット・天井 | 7 | m | | | |
| 計 | | | | | | |
| | | | | | | |
| 電線管 | | 1 | 式 | | | 別紙 00-0060 |
| 厚鋼電線管(G) | 露出配管(塗装有) 70mm | 19 | m | | | |
| 二種金属製可とう電線管(F) (ビニル被覆有) | (76) エキスパンション用等 | 2 | m | | | |
| 配管用アーリック | L150×H70 コムペース付 | 19 | 個 | | | |
| 計 | | | | | | |
| | | | | | | |

電氣設備工事 別紙明細

電気設備工事 別紙明細

| 電気設備工事 | | 動力設備 | | | 動力分岐 | |
|-----------------------------|----------------------|------|-----|-----|------|------------|
| 名 称 | 摘 要 | 数 量 | 单 位 | 单 価 | 金 領 | 備 考 |
| 電動機等接続 | | 1 | 式 | | | 別紙 00-0062 |
| 電動機結線 | 直入始動方式以外 | 3 | 台 | | | |
| 計 | | | | | | |
| | | | | | | |
| 電線 | | 1 | 式 | | | 別紙 00-0063 |
| 600V耐燃性ホリエレ ン絶縁電線(EM-IE) | 5.5mm ² | 45 | m | | | |
| 計 | | | | | | |
| | | | | | | |
| ケーブル | | 1 | 式 | | | 別紙 00-0064 |
| EM-CETケーブル | 38mm ² 管内 | 45 | m | | | |
| 計 | | | | | | |
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電氣設備工事 別紙明細

電氣設備工事 別紙明細

共通仮設費(積上) 明細

現場管理費(積上) 明細